City of Marina



November 25, 2024

City of Marina 211 Hillcrest Avenue Marina, CA 93933 831-884-1278; FAX 831-384-9148 www.cityofmarina.org

OBJECTIVE DESIGN REVIEW (ODS 24-0001) FOR 226 HARBEN CIR. APN 032-031-034

PROJECT OVERVIEW:

The project proposes to construct a new two-story, multi-family apartment building with six (6) dwelling units on a site with an existing one-story, multi-family apartment building with six (6) dwelling units for a total of 12 units. The first floor of the proposed building will include two (2) storage areas, a two-bedroom dwelling unit, and five (5) garage spaces. The proposed second floor will have five (5), one-bedroom dwelling units.

GENERAL PROJECT INFORMATION:

Location	226 Harben Circle
Assessor Parcel No.	032-031-034
General Plan Designation	Residential – Multi-Family (15-35 dwelling units/acre)
Zoning District	R-4 or Multi-Family Residential District (allows 35 du/ac)
Parcel Size	28,289 sq. ft. (0.65 acres)
Owner	Sabu Shake Jr.
Applicant / Designer	Housable, Inc.

Table 1: Project Information

PROJECT LOCATION





Map: R-4 Zoning District

Map: R-MF General Plan


PROJECT CHARACTERISTICS:

DEVELOPMENT STANDARD	STANDARD (Chapter 17.12 R-4 District)	PROPOSED	COMPLIANT (YES/NO)
Lot Size	6,000 sf	28,289 SF / 0.65 Acres	Yes
Height	Max. building height is 42' and three (3) stories	< 42' and 2 stories	Yes
Setbacks	Front Yard: 12' Side Yard: 5' Rear Yard: 10'	Front Yard: 12' Side Yard: 5' Rear Yard: 10'	Yes
Site Coverage	60% max.	The combined site coverage for all buildings is 29%	Yes
Zoning Density (17.12.075.C)	Min. 15 Units / Acre Max. of 35 Units / Acre	Proposed: 6 units Existing units: 6 Total units 12 / 0.65 ac: 18.5 Units / Acre	Yes
Parking (17.44.020)	7, 2-Bedroom Units (1.5 per unit) 5, 1-Bedroom Units (1 per unit) Guest (1 per 5 units)	Existing: 11 spaces Proposed: 8 (5 enclosed) Total: 19 Spaces (18 required)	Yes
Open Space Private (17.12.040)	Min. 80 sf for ground floor Min. 40 sf for 2 nd floor & above	>760 SF	Yes
Common Open Space (17.12.040)	7, 2-Bedroom Units (400 SF per unit) 5, 1-Bedroom Units (350 SF per unit)	4,928 SF (4,550 SF required)	Yes

Table 2: Zoning Standards

EXISTING SITE PLAN:

| Construction | Construction

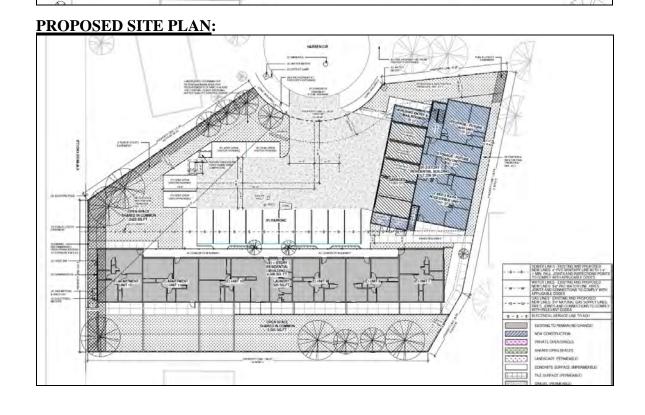

Architectural rendering:



PROJECT ANALYSIS

Zoning Ordinance Consistency:

The proposed project is compliant with the City of Marina Zoning as detailed above in Table 2 (Zoning Standards).

General Plan Consistency:

At 12 units, the project is at the low end of the allowed density in the Residential Multi-Family land use designation (range is 10 - 22 units).

Objective Design Standards Consistency:

The proposed project is compliant with City of Marina's Objective Design Standards as detailed in Attachment #2 - Objective Design Standards Worksheet.

ENVIRONMENTAL REVIEW

Because the project is consistent with the City's ODS and, therefore, subject only to ministerial review, it qualifies for a Categorical Exemption under Section 15300.1 of the California Environmental Quality Act (CEQA) Guidelines and Section 21080 of the Public Resources Code.

CONCLUSION

This request is submitted to the Community Development Director for review and approval.

Respectfully submitted,

Nicholas McSlroy
Nicholas McIlroy, AICP

Senior Planner

City of Marina

The project is hereby **APPROVED** on November 25, 2024, based on the attached Conditions of Approval, Objective Design Standards Worksheet, and Plan Set by:

Guido Persicons

Guido Persicone, AICP
Community Development Director
City of Marina

Attachments:

- 1. Conditions of Approval
- 2. Objective Design Standards Worksheet
- 3. Plan Set

ATTACHMENT #1

CONDITIONS OF APPROVAL

- 1. <u>Substantial Conformance.</u> The project shall be developed in substantial conformance to the plans submitted on October 10, 2024, except as conditioned herein. Any deviation from approvals must be reviewed and approved by staff.
- 2. <u>Indemnification</u>. The Owner/Applicant shall agree as a condition of approval of this project to defend, at its sole expense, indemnify and hold harmless from any liability, the City and reimburse the City for any expenses incurred resulting from, or in connection with, the approval of this project, including any appeal, claim, suit or legal proceeding. The City may, at its sole discretion, participate in the defense of any such action, but such participation shall not relieve the applicant of its obligations under this condition.
- 3. <u>Building Permits.</u> Review and approval by the Public Works, Fire and Building Departments are required prior to issuance of a Building Permit. Work taking place in the public right-of-way shall require an Encroachment Permit prior to issuance of the Building Permit.
- 4. <u>Permit Expiration.</u> This permit will expire and be null and void unless a valid building permit has been applied for within twenty-four (24) months from the date of approval by the final approval body. The applicant may apply for an extension of this permit by submitting an extension request application and applicable fees, no less than 30 days prior to expiration date to the Community Development Director for action by the authorizing body. No renewal notice will be sent to the applicant or property owner.
- 5. <u>Terms and Conditions.</u> These terms and conditions shall run with the land, and it is the intention of the Planning Commission and the Permittee to bind all permittees of the subject property to the terms and conditions, unless amended. Amendments to this permit may be achieved only if an application is made, and the CDD Director, any such amendments pursuant to the Zoning Code regulations.
- 6. <u>Conditions of Approval in Plans</u>. All conditions of approval for the Planning permit shall be included on the second page of the construction plan set submitted to the Building Department. If the conditions cannot fit on the second page, then they may extend to the third page of the plan set.
- 7. <u>Lighting</u>. The Community Development Director or designee or the Planning Commission on appeal shall retain the right to require reduction in the intensity of illumination after the installation of any illuminated sign if said illumination creates any undue public nuisance per MMC 17.46.160.C.
- 8. <u>Utilities—Underground</u>. All new utility and distribution lines shall be placed underground unless required by the utility company, in which case they shall be screened.

- 9. Archeology and Inadvertent Discovery. When human remains or other cultural artifacts are exposed, the Health and Safety Code § 7050.5 requires that no further excavation or disturbance occurs in the area and that the county coroner is called so that the coroner can verify that the remains are not subject to medical jurisprudence. Within 24 hours of notification, the coroner calls the Native American Heritage Commission if the remains are known or thought to be Native American. The Native American Heritage Commission selects the Most Likely Descendant (MLD) from a rotating list of MLDs. The MLD has 24 hours to respond. All work will halt with a 50-yard radius until an osteologist can examine the remains, and a treatment plan for any said remains has been provided according to the MLD.
- 10. <u>Cultural and/or Archaeological Artifacts.</u> If such artifacts are unexpectedly discovered during ground disturbing activities, work shall be halted until the item(s) can be evaluated by a qualified professional archaeologist. If the find is determined to be significant, appropriate mitigation will be formulated, with the approval of the lead agency, and implemented prior to recommencement of work.
- 11. <u>Road, Sidewalk, and Landscape Condition.</u> All affected roads, sidewalks, and landscape shall be restored to original or better condition. Any work done in the public right-of-way requires an encroachment permit from the Public Works Department.
- 12. <u>Fire Department</u> Marina Fire Department standard conditions shall be implemented to the satisfaction of the Fire Chief.
- 13. <u>Trash Enclosures and Maintenance Building</u> Prior to the issuance of building permits the applicant submit shall coordinate with the waste hauler for the site and submit proof that adequate service will be accommodated/contracted for the project site.
- 14. <u>Construction Noise Reduction Measures</u> Building and / or grading plans shall clearly state the noise limitation requirements of Municipal Code Section 15.04.055.
- 15. <u>Public Works</u> That the applicant shall provide the following for the Building/Grading Permit Plan Review submittal:
 - Preliminary Title Report not more than 6 months old.
 - Hydrology Report for the proposed on-site drainage system.
 - o Show all proposed spot elevations showing positive drainage away from all proposed structures and property lines.
 - o Show the filtration (for parking lots) and retention systems for capturing on-site runoff with pipe sizing and invert elevations. Show a driveway catchment system preventing runoff from leaving the property.
- 16. <u>Permit Authorization and Signature.</u> The Design Review and Sign Permit is not valid, and construction shall not commence until the below affidavit is signed and approved by the Executive Director of Interim, Inc. Conditions are returned to the Community Development Department.
 - a. I attest to the truth and correctness of all the facts, exhibits, maps, and attachments presented with and made a part of the application for the Marina Kai Apartments project located at 605 Bayonet Circle.

c. I acknowledge that any changes to the conditions of approval would require modification of the conditional use permit by the approval authority.

Applicant's Name:

Applicant's Signature:

Date:

d. I am the owner/owner's representative (Executive Director) of the property involved in this project, and I authorize the person named above to act on my behalf throughout the duration of the project.

Property Owner's Name:

Property Owner's Signature: ______ Date: _____

b. I understand and agree to implement all conditions throughout the duration of the

ATTACHMENT #2 OBJECTIVE DESIGN STANDARDS WORKSHEET

(On Separate Sheet)

ATTACHMENT #3 PLAN SET

(On Separate Sheet)



Objective Design Standards (ODS) Worksheet R-4 Multi-Family Residential

Project Address: 226 HARBEN CIR MARINA CA 93933 Date: 10/28/24

Project Address: 220 HANDLIN CITY WANTINA CA 95955				0/20/24
Characteristic	Standard	Proposal (fill in all that apply)	Consistent and Sheet #	Reference
Access and Conne	ectivity			
Block size	New development >5 acres: Max. 400' block length	7338 SF	G0.1	ODS 1.3.1(B)(1)
Dead-end streets	New development: Deadend streets longer than 400' require connection via pedestrian path		G1.0, A1.0	ODS 1.3.1(B)(3)
Driveways and curb cuts	New development: Min. 100' from any street intersection For parcels <100' wide, along lot line farthest from intersection 1 driveway/curb cut per 400' of public street frontage	(E) curb cut	G1.0, A1.0	ODS 1.3.1(B)(4)
External connectivity	New development (to extent feasible): Connect internal streets and pathways to existing and proposed external streets and pathways Align new streets with existing street intersections Locate and algin new streets to allow for future direct connections to other streets		A1.0	ODS 1.3.1(B)(2)
Parking access hierarchy	In order of preference: 1. Via alley 2. Via driveway shared w/ property abutting site 3. Via secondary street or street w/ lower General Plan classification 4. Via primary street	Via (E) driveway	A1.0	ODS 1.3.1(B)(5)
Multi-modal site access	Via pedestrian or multi-use pathways: Connect buildings on site Connect buildings on street frontage to public sidewalk Connect bike parking areas to building entrances and sidewalk	Via Pathway	A1.0	ODS 1.3.1(B)(6)

Characteristic	Standard	Proposal (fill in all that apply)	Consistent and Sheet #	Reference
Pedestrian access	Separate and distinct from driveways, connection to public sidewalk			ODS 1.3.1(D)(2)
Pedestrian pathways	 Min. 5' wide connecting buildings Change in grade, materials, textures, or colors where crossing vehicular route 			ODS 1.3.1(B)(6) ODS 1.3.1(B)(7)
Building Design				
Building height	Max. 42' and three stories (whichever is less)	27'-1", 2 story		MMC 17.12.060(A)
Building length	Max. 300'	74'-4"	A2.2	ODS 1.3.2(B)
Frontage	Min. 75% of façade at min. setback line (see Figure 8 in ODS document)		A1.0, A2.0	ODS 1.3.2(A)
Components	If designed in a traditional style, min. defined base and top		N/A	ODS 1.3.2(E)
Floor height	Setback ≤ 10': min. 3' above grade; max. 5' above grade Setback > 10': min. 0' above grade; max. 3' above grade		N/A	ODS 1.3.2(M)
Massing breaks	For building 3 stories or higher: • Buildings ≥ 100' in length – 1 major massing break; min. 8' depth, 10' width • Buildings ≥ 200' in length – 2 major massing breaks; with one break min. 10' depth, 20' width; other min. 5' depth, 10' width For all buildings: • Building facades >75' – at least 1 minor massing break; min. 2' deep and 5' width		N/A	ODS 1.3.2(C)(1) ODS 1.3.2(C)(1)
Articulation	At least two of the following: Recesses Projections Datum lines Balconies Screening devices	Projection, Balco	A3.0	ODS 1.3.2(F)
Entrances	Primary Shared Residential Entries			ODS 1.3.2 (M)(2) & (3)

Characteristic	Standard	Proposal (fill in all that apply)	Consistent and Sheet #	Reference
Entrances continued	 At least one ped. entry for each building on each primary street frontage, unless a greater number is required by the adopted Building or Fire Codes. A single corner entry may be provided to fulfill this requirement. Primary shared building entries shall face or be directly visible from the public ROW or a publicly-accessible path/open space. This may be through a lobby, front porch, or forecourt (or combo). Primary shared entries shall provide weather protection that is a min. 8' wide and 6' deep by fully or partially recessing the entry, providing an 			
	awning/canopy, or using a combo of these methods. Primary Individual Residential Entries • A min. 50 % of the ground floor residential units that face a public ROW, publicly-accessible path, or open space shall have unit entries that face the			
	street, path, or open space (Senior units or other deed restricted units for special populations are exempt.). • Primary ground-floor entrances serving individual residential units shall include weather protection that is a min. of 4' wide and 4' deep by recessing the entry, providing an awning/canopy, or using a			

Characteristic	Standard	Proposal (fill in all that apply)	Consistent and Sheet #	Reference
	combination of these methods.	,		
Corner buildings	Located at min front and street side yard setback line for a min. of 50' aggregated length OR Corner plaza; min. size 400 sf and min. dimension 20' either direction	not corner	N/A	ODS 1.32(I)
Roof edge treatment	One of 3 options (see ODS document)	2	A3.0	ODS 1.32(J)
Rhythm and pattern	 Vertically oriented façade, articulation, or vertically oriented patterns of fenestration 20' – 50' in width of linear frontage 			ODS 1.3.2(D)
Step backs	Each floor above the third floor: 15'/every two floors	2 story only	N/A	ODS 1.3.1(A)(1)
Fenestration	 Max. 2:1 horizontal to vertical ratio Windows recessed min. 3" from plane of surrounding exterior wall OR combo trim and min. 1" recess 			ODS 1.3.2(H)
Window placement	 Upper story between 5'-10' of property line: Min. 3' offset Upper story <5' from property line: Min. 5' offset (see exceptions re. non-habitable rooms) 	more than 10' se	N/A	ODS 1.3.1(A)(2)
Balcony placement	Upper story: Min. 10' offset from windows of adjacent SF residences			ODS 1.3.1(A)(3)
Building Materials	and Colors			
Colors	 The main (primary) color shall be used on a majority of the building façade Accentuate façade elements or upper floors with secondary colors Limit accent colors to moldings, trims, bulkheads, doors Garage to be painted using at least two of the same exterior finish 	color white	A3.0, A3.1, A4.	ODS 1.3.2(N)(2)

Characteristic	Standard	Proposal (fill in all that apply)	Consistent and Sheet #	Reference
	materials and/or colors used on the principal structure.			
Materials	Min. 2 on any frontage; at least 20% coverage per material (excluding windows, railings, base bulkheads, trim)			ODS 1.3.2(N)(1)
Material changes	At corners, must offset material change by min. 2" depth, 4' distance			ODS 1.3.2(N)(3)
Prohibited finish materials	Untextured block, plywood, vinyl, plastic, laminate, corrugated metal, mill-finish aluminum metal windows or door frames, fiberglass			ODS 1.3.2(N)(4) ODS 1.3.2(N)(5)
Vents, flashing, conduits, gutters and downspouts	Painted to match adjacent surface unless approved decorative material			ODS 1.3.2(N)(6)
Landscaping				
Drought tolerant plantings	 Required for min. 65% of total landscaped areas Locally native species strongly encouraged 		L3.01	ODS 1.3.1(F)(7)
Landscape buffer – front setback	Min. 40% of front yardMin. one tree per 40' linear street frontage		L3.01	ODS 1.3.2(K)(8)
Landscape buffer – property boundary	 At least 5' along abutting interior property lines and adjoining SF zoning districts Trees every 20'-40' on center 		L3.01-L3.10	ODS 1.3.1(A)(4)
Landscape buffer – interior streets and pathways	 At least 4' along interior streets and paths One tree every 30 to 45 feet At least 30% shrubs and ground cover of planting strip 	yes	L3.01-L3.10	ODS 1.3.1(F)(1)
Plant size	 Shrubs: 5-gallon, or 15-gallon if used for screening Trees: 15-gallon, min. 50% of trees at 24" box size, including all trees for screening; 		L3.01	ODS 1.3.1(F)(5)
Plant spacing	• Shrubs: Min. 2' • Trees: Min. 4'	ok	L3.10	ODS 1.3.1(F)(5)

Characteristic	Standard	Proposal (fill in all that apply)	Consistent and Sheet #	Reference
	All: Spaced to accommodate mature plant size			
Soil and mulch	 Native soil in all planting areas amended to min. depth of 6" with min. 40% organic material Min. 2" organic mulch in non-turf areas (unless ground cover is used) 	3" mulch	L3.10	ODS 1.3.1(F)(10)
Tree location	 Within 5' of ROW or parking area: deep-rooted species or root barrier Within ROW, utility easement, or 10' of public improvement: Approval from PW Dept. required 	adjacent to visitc	L3.01	ODS 1.3.1(F)(4)
Tree species	Selected from Recommended List of Preferred Trees			ODS 1.3.1(F)(6)
Tree preservation	All trees 6" DBH or greater, unless infeasible	All trees will remain	L3.01-L3.10	ODS 1.3.1 (F)(3)
Turf	 Max. 25% of total landscaped areas Not allowed in median strips 			ODS 1.3.1 (F)(7)
Turf – natural	Not allowed on slopes exceeding 4:1 ratio	No turf	N/A	ODS 1.3.1 (F)(8)
Turf – artificial	 Keep at least 5' away from tree root crowns Requires proper drainage system 			ODS 1.3.1 (F)(9)
Gopher barriers	Install gopher barriers	No turf	N/A	ODS 1.3.1.(F)(14)
Lighting		I	1	
Pedestrian- oriented lighting	Min. intervals of 40' along pathways; max. height 12'	yes	E1.0	ODS 1.3.1(E)(1)
All other lighting	Max. height:12' within 15' of SF zoning districts16' in all other locations		E1.0	ODS 1.3.1(E)(2)
Lighting intensity and trespass	Max. 1,000 lumens; directed, oriented, and shielded to prevent glare		E1.0	ODS 1.3.1(E)(3) ODS 1.3.1(E)(4)
Lighting temperature	Max. 3,000 Kelvin	3000k	E1.0	ODS 1.3.1(E)(6)

Characteristic	Standard	Proposal (fill in all that apply)	Consistent and Sheet #	Reference
Lighting – attachment to buildings	Attach to walls or eaves only; fixture not to exceed height of parapet, roof, or eave			ODS 1.3.1(E)(5)
Open Space		T		I
Common open space	 Min. 20' in any direction Max. 50% coverage with shading device or roof structure Seating required Min. 20% landscaped Min. one tree per 600 sq. ft. aggregate open space area Slopes 5% or less 	2423 SF	A1.0	ODS 1.3.1(G)(1)
Common open space – calculation	Min. 350 sq. ft. per 1-BR + Min. 400 sq. ft. per 2-BR – Private open space = Total		A1.0	MMC 17.12.040(A)
Common open space amenities	See table in ODS document		L1.10	ODS 1.3.1(G)(2)
Private open space	 Directly accessible from residential unit Min. clear height: 8' Ground floor: Min. 10' in at least one direction Upper floor: Min. 5' in any direction 	3350	G0.1/ A1.0	ODS 1.3.1(G)(3)
Private open space – calculation	 Ground floor units: Min. 80 sq. ft. Upper floor units: Min. 40 sq. ft. 		G0.1/ A1.0	MMC 17.12.040(B)
PAPOS	If provided: • Min. 20' in one direction and 15' in other direction. • Min, area 400sf • Max. 40% covered • Min. 1 tree/400sf • Min. 20% planted with shrubs and/or ground cover	4928 sf	G0.1/ A1.0	ODS 1.3.1(G)(4)
Parking				
Required parking	 1 space per 1-BR 1.5 spaces per 2-BR 1 additional space for each 5 units or fraction 		A1.0, G0.1	MMC 17.44.020 (D)
Location and frontage	New development: • Prohibited in front and street side setbacks		A1.0	ODS 1.3.1(D)(1)

Characteristic	Standard	Proposal (fill in all that apply)	Consistent and Sheet #	Reference
	 Underground or in structures/lots to rear or side of buildings Surface parking = Max. 30% of street frontage If more than one frontage, no parking along primary frontage 	surface	A1.0	
Pedestrian routes through parking	New development >4 units: Connect to building entries and public sidewalk via on-site pathway Min. 1 pathway for every 4 rows parking Pathways separated from travel lanes, hardsurfaced, min. 4' width Change in materials, textures, colors, and/or grade at vehicular/pedestrian conflict points			ODS 1.3.1(D)(2)
Screening	Communal and individual			
Refuse containers	Communal and individual refuse, recycling, and compost/green waste areas/containers, rooms or enclosures shall be adequate in capacity, number, and distribution to accommodate all waste generated onsite. The number and type of containers and collection areas shall be reviewed and approved by the local disposal service.		A7.3	ODS 1.3.1(C)(4) ODS 1.3.1(C)(5)
Rooftop equipment	Set back at least 10' from roof edge or screened Paint to match rooftop in color if visible from taller buildings or higher grades		A2.2	ODS 1.3.1(C)(3)
Utilities, storage and service areas	Fully screened equal to or higher than height of equipment		A1.0, A2.0	ODS 1.3.1(C)(1) ODS 1.3.1(C)(2)

Characteristic	Standard	Proposal (fill in all that apply)	Consistent and Sheet #	Reference
Parking structure	New structure: Ground level lined with R or C uses at min. 20' depth or required active frontage depth, whichever is greater Max. 2 upper levels may extend to façade Both ground and upper levels designed and treated with same level of detail/articulation as primary buildings on site			ODS 1.3.1(D)(3)
Surface parking	Five or more spaces: Max. 3' fence height on street frontage (alleys exempt) 6' fence height along interior lot lines abutting R zones, except within front setback (3') Prohibited materials: plain concrete blocks unless capped and finished with stucco or other approved material, barbed wire, chain link Closely spaced plants to form opaque screen			ODS 1.3.1(D)(4)
Site Devel	opment Standards (R-4, or Mul	ti-Family Residential		
Standard	Requirement	Proposed	Consistent	MMC Section
Density	Min. 15 units/acre Max. 35 units/acre	18 units/acre	G0.1	MMC 17.12.075
Setback – front	Min. 12'	12'	A1.0	MMC 17.12.110
Setback – rear	Min. 10', or 20' where rear yard abuts R-1 or R-2 zone	10'	A1.0	MMC 17.12.130
Setback – side	Min. 5', or 12' where side yard abuts R-1 or R-2 zone	5'	N/A	MMC 17.12.120
Site area	Min. 6,000 sq. ft.	28289	G1.0	MMC 17.12.070
Site coverage	Max. 60%	25%	A1.0	MMC 17.12.100
Site depth	Max. avg. no more than 3x site width	120	G1.0	MMC 17.12.090
Site width	Min. avg. 60'	80	G1.0	MMC 17.12.080

226 HARBEN CIR MARINA CA 93933 SCHEMATIC DESIGN





NOTES: SCHEMATIC DESIGNS, NOT FOR CONSTRUCTION.

Revisions			
No.	Description	Date	
•		·	

Sabu Shake Jr. sabu@fishhopper.com 226 Harben Cir Marina Ca 93933

HARBEN
APARTMENTS
SCHEMATIC DESIGN

G0.0

COVER SHEET

PROJECT INFORMATION

CONSTRUCTION TYPE: OCCUPANCY TYPE: R1 & R2 APN: 032031034000 **ZONING DISTRICT: R-4**

CONSTRUCTION LOCATION: 226 Harben Cir Marina Ca 93933

PROJECT SCOPE:

DEVELOPMENT OF A 6 UNIT APARTMENT BUILDING, WITH THE POTENTIAL TO CONVERT NEW STORAGE SPACES INTO 2 ADDITIONAL ADUS.

OWNER: MARINA HARBEN APTS LLC

700 Cannery Row, Monterey, CA. 93940 831-372-2406 sabu@fishhopper.com

DESIGNER: HOUSABLE INC.

2269 Chestnut St #122, San Francisco, CA 94123 2135771557

lj@housable.com

PROPERTY INFO:

LOT SIZE: 28,289 SQ.FT. 0.62 ACRES.

REQUIRED SHARED OPEN SPACE: $400SF \times (6(E)+6(N)) \text{ UNITS} = 4800SF$ PROPOSED OPEN SPACE: 4928SF

FIRE SPRINKLERS:

NEW CONSTRUCTION TO BE EQUIPPED WITH FIRE SPRINKLERS

DEVELOPMENT STATISTICS

PROPOSED RESIDENTIAL BUILDING

TOTAL BUILDING SIZE = 7338 SF TOTAL BUILDING HEIGHT = 27' 9"

NUMBER OF STORIES: 2 STORIES

FRONT SETBACK: 12'

REAR SETBACK: 10'

SIDE YARD SETBACK(S): 5'

COVERAGE: ALLOWED 60% COVERAGE = 16,973 SF EXISTING RESIDENTIAL BUILDING = 4,500 SF PROPOSED RESIDENTIAL BUILDING = 3,669 SF TOTAL PROPOSED COVERAGE = 8,169 SF (29%)

PARKING STATISTICS

TOTAL REQUIRED PARKING = 19 OPEN PARKING = 14 COVERED PARKING = 5 VISITOR PARKING = 4

APPLICABLE CODES


MARINA MUNICIPAL CODES **BUILDING CODE:**

2022 CALIFORNIA BUILDING CODE

ENERGY CODE: 2022 CALIFORNIA ENERGY EFFICIENCY STANDARDS CODE CALIFORNIA GREEN BUILDING STANDARDS CODE

MECHANICAL CODE: 2022 CALIFORNIA MECHANICAL CODE **ELECTRICAL CODE:** 2022 CALIFORNIA ELECTRICAL CODE **PLUMBING CODE:**

2022 CALIFORNIA PLUMBING CODE FIRE PROTECTION: 2022 CALIFORNIA FIRE CODE

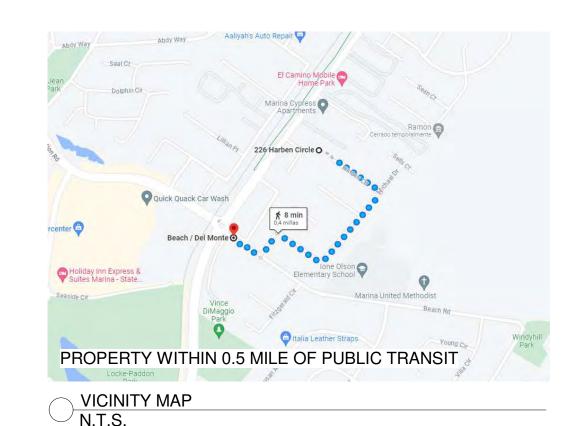

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A2.0	PROPOSED FLOOR PLAN - LEVEL 1
A2.1	PROPOSED FLOOR PLAN - LEVEL 2
A2.2	PROPOSED ROOF PLAN
A2.4	CONVERSION FLOOR PLAN - LEVEL 1
A3.0	PROPOSED ELEVATIONS
A3.1	PROPOSED ELEVATIONS
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L2.10	IRRIGATION DETAILS
L2.20	IRRIGATION SPECIFICATIONS
L2.21	IRRIGATION SPECIFICATIONS
L3.01	PLANTING PLAN
L3.02	IRRIGATION PLAN
L3.10	PLANTING DETAILS
L3.20	PLANTING SPECIFICATIONS
L3.21	PLANTING SPECIFICATIONS

ABBREVIATIONS ANNOTATIONS DDAMINIO INIDEV @ At # Pound or Number 1 **DETAIL MARK** A.B. Anchor Bolt A101 🛴 ADU Accessory Dwelling Unit (Secondary Dwelling Unit) Number Sheet Number A.F.F. Above Finished Floor A.F.G. Above Finished Grade **ELEVATION MARK** BLDG. Building BLKG. Blocking Direction <1 | A101 ★1 ★薬 BM. Beam Number B.O. Bottom Of Sheet Number CERT. Certificate C.I. Contractor Installed C.F. Contractor Furnished CLR. Clear **SECTION MARK** C.L. Center Line Direction CLNG. Ceiling A101 Number CONT. Continuous Sheet Number COL. Column DIA. Diameter Name Elevation DET. Detail **LEVEL MARK** D.F-L. Douglas Fir-Larch DBL. Double (E) Existing EA. Each **SPOT ELEVATION** EQ. Equal MARK E.W. Each Way FIN. Finish 3.0 1 View Name 1/8" = 1'-0" F.O. Face Of **VIEW REFERENCE** FT. Foot or Feet HDR. Header HT. Height JST. Joist **ROOM MARK** MAX. Maximum Room name Room Designation M.B. Machine Bolt

MIN. Minimum

MTD. Mounted

NOM. Nominal

(N) New

O/ Over O/A Overall

Way)

N.I.C. Not In Contract

N.T.S. Not To Scale

O.F. Outside Face,

O.I. Owner Installed OPP. Opposite

(P) Proposed

PLY. Plywood

PTD. Painted

RET. Retaining

O.C.(E.W.)On Center (Each

PL. Plate or Property Line

P.T. Pressure Treated

REINF. Reinforced

R.F. Roof Framing

SHTG. Sheathing

SHT. Sheet

SIM. Similar

SQ. Square

T.O. Top Of

TYP. Typical

W/O Without

W/ With

V.I.F. Verify In Field

W.F. Wall Framing

W.O. Where Occurs

U.O.N. Unless Otherwise Noted NOTE: Not all abbreviations and symbols shown here are used

STD. Standard STR. Structural

T.B.D. To be determined

R.O. Rough Opening S.F. Square Feet

S.S.D. See Structural Drawings

Owner Furnished



NOTES: PRELIMINARY DESIGNS, NOT FOR CONSTRUCTION.

Size

NORTH ARROW

GRID LINE MARK

WALL TYPE MARK

WINDOW TYPE

REVISION MARK

DOOR TYPE MARK

KEYNOTE

MARK

MARK

MARK

Identifier

FLOOR /

CEILING TYPE

FOUNDATION

SHEAR WALL

MARK

150 SF 🔫

 $\left(\begin{array}{c}\mathbf{0}\end{array}\right)$

√1i

1

101

K1

C8

F8

	Revisions	
No.	Description	Date

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226 Harben Cir Marina Ca 93933

HARBEN **APARTMENTS** SCHEMATIC DESIGN

G0.1

PROJECT INFORMATION

ZONING REQUIREMENT:

- R-4 ZONE.

- 15-35 UNITS PER ACRE ALLOWED PER ZONING.

- TARGETING 12 UNITS WITHOUT CHANGING THE EXISTING 6 UNITS AND 2 ADUS.

NOT LOCATED IN A COASTAL ZONEMAX LOT COVERAGE: 60%.MAX HEIGHT: 42 FEET, 3 STORIES.

- SETBACKS: - SIDE YARD: 5 FEET GENERALLY AND 12 FEET IF ABBUTTING R-1 OR R-2 ZONE.

- REAR YARD: 10 FEET GENERALLY AND 20 FEET IF ABBUTTING R-1 OR R-2 ZONE.

- FRONT YARD: 12 FEET GENERALLY MEASURED FROM THE FRONT PROPERTY LINE OR THE EDGE OF THE EASEMENT FOR A PRIVATE ROADWAY, WHICHEVER IS LESS.

-"SITE COVERAGE" MEANS THE PERCENT OF THE SITE AREA COVERED BY PRINCIPAL AND ACCESSORY BUILDINGS. (ORD. 2020-07 § 2, 2020; ORD. 2002-03 § 1, 2002).

TOTAL OPEN SPACE REQUIRED:

THE MINIMUM AREA OF OPEN SPACE REQUIRED FOR MULTIPLE-FAMILY DWELLINGS OR THREE OR MORE SINGLE-FAMILY DWELLINGS ON A BUILDING SITE IN THE R-4 DISTRICT SHALL BE THREE HUNDRED SQUARE FEET PER EFFICIENCY APARTMENT, THREE HUNDRED FIFTY SQUARE FEET PER ONE-BEDROOM UNIT, AND FIFTY ADDITIONAL SQUARE FEET FOR EACH ADDITIONAL BEDROOM. A PORTION OR ALL OF THE REQUIRED USABLE OPEN SPACE SHALL BE PRIVATE AS PROVIDED BY THIS SECTION; OTHERWISE IT SHALL BE SHARED IN COMMON.

PRIVATE OPEN SPACE:

A MINIMUM OF EIGHTY SQUARE FEET FOR GROUND FLOOR UNITS AND FORTY SQUARE FEET FOR UNITS LOCATED ON SECOND LEVELS AND ABOVE. (ORD. 2020-07 § 2, 2020; ORD. 2006-03 § 1 (EXH. A), 2006).

D. MULTIPLE DWELLINGS:

1. ONE-BEDROOM UNITS AND EFFICIENCIES: ONE SPACE FOR EACH DWELLING UNIT WHICH SHALL BE COVERED PLUS ONE ADDITIONAL SPACE FOR EACH FIVE DWELLING UNITS OR FRACTION

2. TWO-BEDROOM UNITS: ONE AND ONE-HALF SPACES FOR EACH DWELLING UNIT, ONE OF WHICH SHALL BE COVERED PLUS ONE ADDITIONAL SPACE FOR EACH FIVE DWELLING UNITS OR FRACTION THEREOF,

3. THREE OR MORE BEDROOM UNITS: TWO SPACES FOR EACH DWELLING UNIT, ONE OF WHICH SHALL BE COVERED PLUS ONE ADDITIONAL SPACE FOR EACH FIVE DWELLING UNITS OR FRACTION THEREOF,

THEREOF,

4. GENERAL NOTE. ALL REQUIRED ON-SITE
PARKING SPACES SHALL BE UNIFORMLY
DISTRIBUTED THROUGHOUT THE DEVELOPMENT
TO THE SATISFACTION OF THE SITE AND
ARCHITECTURAL DESIGN REVIEW BOARD,
5. GENERAL NOTE. TWENTY PERCENT OF ALL
REQUIRED PARKING SPACES, BUT IN NO CASE
LESS THAN ONE SPACE, SHALL BE KEPT
UNRESERVED AND AVAILABLE FOR VISITOR
PARKING. VISITOR PARKING SPACES SHALL BE
IDENTIFIED BY A SIGN OR OTHER MEANS AND
SHALL BE UNIFORMLY DISTRIBUTED THROUGHOUT
THE DEVELOPMENT TO THE SATISFACTION OF THE
SITE AND ARCHITECTURAL DESIGN REVIEW
BOARD.

PARKING:

- 1BD - 1 SPACE (1 COVERED) + 1 PER 5 - 2BD - 1.5 SPACES (1 COVERED) + 1 PER 5 - 3BD - 2 SPACES (1 COVERED) + 2 PER 5 - 20% FOR VISITOR SPACES REQUIRED PARKING SPACE SHALL BE A MINIMUM OF NINE FEET BY NINETEEN FEET

GENERAL NOTES

- 1. CONSTRUCTION WORKMANSHIP AND MATERIALS SHALL CONFORM TO: NOTES IN THIS SET OF CONSTRUCTION
- DOCUMENTS, ALL APPLICABLE LOCAL CODES AND ORDINANCES AS NOTED THROUGHOUT THESE DRAWINGS.

 2. IN THE EVENT OF CONFLICT BETWEEN PERTINENT CODES AND REGULATIONS AND REFERENCED STANDARDS OF THESE SPECIFICATIONS, THE MORE STRINGENT PROVISIONS SHALL GOVERN.
- 3. THE PROJECT CONTACT SHALL POSSESS ALL APPROVALS AND PERMITS PRIOR TO COMMENCING ANY SITE PREPARATION, MATERIAL ORDERS OR CONSTRUCTION ACTIVITY. THE PROJECT CONTACT IS RESPONSIBLE FOR DETERMINING AND COORDINATING THE SCHEDULE FOR ALL PROJECT ACTIVITY.
- 4. PROJECT SCOPE IS LIMITED TO WHAT IS LISTED IN THE PROJECT SCOPE SECTION OF THE COVER SHEET
- THESE PLANS ARE INTENDED FOR STANDARD ON-SITE CONSTRUCTION METHODS ONLY. THE PROJECT CONTACT
 ASSUMES FULL RESPONSIBILITY AND ANY RISKS ASSOCIATED WITH DEVIATION FROM STANDARD ON-SITE
 CONSTRUCTION METHODS.
- 6. DIMENSIONS: UNLESS NOTED OTHERWISE, ALL DIMENSIONS ARE SHOWN AS FOLLOWS: FACE OF WALL AT MASONRY, INDICATED FACE OF STUD, CENTER LINE, GRID LINE, TOP OF CONCRETE SLAB OR FOUNDATION, TOP OF PLYWOOD, ETC. DRAWINGS SHALL NOT BE SCALED TO DETERMINE ANY DIMENSIONS, REFER ONLY TO WRITTEN INFORMATION AND DETAIL DRAWINGS, OR USE FIGURED DIMENSIONS. DIMENSIONAL DISCREPANCIES SHALL BE CALLED TO THE ATTENTION OF THE PROJECT CONTACT PRIOR TO CONSTRUCTION.
- 7. BUILDING INSPECTORS MAY APPROVE DEVIATION FROM THESE PLANS. IN SUCH CASE, THE PROJECT CONTACT SHALL NOTIFY ALL OTHERS OF SUCH DEVIATION AND SHALL ASSUME ALL RISKS AND RESPONSIBILITIES ARISING FROM SUCH DEVIATION.
- 8. OMISSIONS: IN THE EVENT CERTAIN FEATURES OF THE CONSTRUCTION ARE NOT FULLY SHOWN ON THE DRAWINGS, THEIR CONSTRUCTION SHALL BE OF THE SAME CHARACTER AS FOR SIMILAR CONDITIONS THAT ARE SHOWN. IF FEATURES ARE STILL UNCLEAR, CONTACT THE PROJECT CONTACT FOR CLARIFICATION.
- 9. THE PROJECT CONTACT OR THEIR REPRESENTATIVE SHALL BE AT THE SITE TO SUPERVISE AND COORDINATE CONSTRUCTION AT ALL TIMES WHILE WORK IS IN PROGRESS.
- 10. THE PROJECT CONTACT SHALL ASSUME SOLE AND COMPLETE RESPONSIBILITY FOR JOB SITE CONDITIONS DURING CONSTRUCTION OF THIS PROJECT, INCLUDING THE SAFETY OF ALL PERSONS AND PROPERTY CONTINUOUSLY AND NOT LIMITED TO NORMAL WORKING HOURS. THE PROJECT CONTACT SHALL DEFEND, INDEMNIFY, AND HOLD THE DESIGNER HARMLESS FROM ANY AND ALL LIABILITY, REAL OR ALLEGED, IN CONNECTION WITH THE PROJECT. THE DESIGNER SHALL BE NAMED AS AN ADDITIONAL INSURED ON THE PROJECT CONTACT'S LIABILITY INSURANCE COVERAGE.
- 11. PROJECT CONTACT SHALL OBSERVE THE CONSTRUCTION OF THIS PROJECT AND SHALL BE RESPONSIBLE FOR FINAL DIMENSIONS, QUANTITIES, COORDINATION OF THE WORK OF ALL TRADES, QUALITY CONTROL, AND CONSTRUCTION STANDARDS FOR THE PROJECT.
- 12. PROJECT CONTACT AND OR CONTRACTORS SHALL PROPERLY DISPOSE OF ALL WASTE CAUSED BY THEIR WORK, KEEP PREMISES JOB SITE CLEAN OF SUCH WASTE AND SHALL KEEP PREMISES "BROOM CLEAN" AT ALL TIMES.
- 13. THE PLAN SET PROVIDED SHOULD ONLY BE MODIFIED UPON DIRECTION OF THE PROJECT CONTACT.
- 14. HEATING AND AIR CONDITIONING, PLUMBING AND ELECTRICAL DRAWINGS OR NOTES INCLUDED HEREIN ARE FOR REFERENCE ONLY. THE PROJECT CONTACT SHALL PROVIDE AND OR SOURCE DESIGN/BUILD DOCUMENTATION FOR THESE ITEMS DIRECTLY FROM SUPPLIERS OR FROM THEIR SUBCONTRACTORS IN ACCORDANCE WITH THESE DRAWINGS AND CRITERIA, AND IN CONFORMANCE WITH ALL CODES AND ORDINANCES, AND SHALL OBTAIN PERMITS FOR THIS WORK.
- 15. EXISTING SITE INFORMATION FOR THESE DRAWINGS SHALL BE DEEMED TO BE ACCURATE BY THE PROJECT CONTACT.
- 6. PRIOR TO THE START OF WORK, THE PROJECT CONTACT SHALL COMPARE AND COORDINATE STRUCTURAL AND DESIGN DRAWINGS WITH EXISTING FIELD CONDITIONS. THE PROJECT CONTACT IS RESPONSIBLE FOR CODE-COMPLIANT CHANGES TO THE PLAN SET AND CONTACTING APPROPRIATE PARTIES FOR STRUCTURAL CHANGES TO THE PROJECT. NO DEVIATION FROM THESE PLANS SHALL BE MADE AND BE ACCEPTED EXCEPT UPON WRITTEN APPROVAL FROM THE PROJECT CONTACT.
- 17. ALL WORK SHALL BE EXECUTED IN ACCORDANCE WITH THE CALIFORNIA BUILDING CODE & RESIDENTIAL CODE, AND OTHER APPLICABLE CODES. THE PROJECT CONTACT SHALL BE RESPONSIBLE FOR THE SATISFACTORY COMPLETION OF THE WORK IN ACCORDANCE WITH THESE PROJECT PLANS AND SPECIFICATIONS. THE PROJECT CONTACT SHALL PROVIDE TERMITE AND MOISTURE PROTECTION AS REQUIRED BY CODE.
- 18. THE PROJECT CONTACT SHALL BE RESPONSIBLE FOR WORKING CONDITIONS AT THE JOB SITE, INCLUDING THE SAFETY OF ALL PERSONS AND PROPERTY DURING THE PERFORMANCE OF THE WORK.
- 19. IT SHALL BE THE PROJECT CONTACT'S RESPONSIBILITY TO ASCERTAIN THE EXISTENCE AND LOCATION OF ANY AND ALL UNDERGROUND UTILITIES AND FACILITIES WHICH MAY BE SUBJECT TO DAMAGE OR INTERRUPTION AS A RESULT OF ITS OPERATIONS. THE PROJECT CONTACT SHALL TAKE ALL PRECAUTIONS NECESSARY TO PROTECT THESE UNDERGROUND UTILITIES / FACILITIES, AND TO MAINTAIN SERVICE TO THE PROPERTY, AND SHALL BE RESPONSIBLE FOR REPAIR TO SAME IF DAMAGED DURING CONSTRUCTION.
- ANY EXCAVATION MUST COMPLY WITH EXCAVATION SAFETY IN ACCORDANCE WITH GOVERNMENT CODE 4216.
 ANY FOUNDATION AND OR UTILITY TRENCHES SHALL BE CLEAN AND FREE OF LOOSE MATERIAL AT THE TIME OF CONCRETE AND OR UTILITY PLACEMENT. THE PROJECT CONTACT SHALL CONDUCT ITS OPERATIONS SUCH THAT EXCAVATIONS REMAIN OPEN FOR A MINIMAL AMOUNT OF TIME BEFORE CONCRETE IS CAST AND OR UTILITY CONNECTION IS INSTALLED.
- 22. NO PERSON(S) SHALL USE ANY PUBLIC ACCESS ROAD OR FIRE TRAIL FOR THE STORAGE OF ANY CONSTRUCTION MATERIAL, STATIONARY CONSTRUCTION EQUIPMENT, CONSTRUCTION OFFICE, PORTABLE REFUSE CONTAINER, OR EARTH FROM ANY GRADING OR EXCAVATING.
- 23. THE PROJECT CONTACT SHALL BE SOLELY RESPONSIBLE FOR VERIFYING THE ACCURACY OF ALL DRAWINGS AND SPECIFICATIONS PROVIDED THROUGHOUT THIS PLAN SET. ANY MATERIAL OMISSIONS OR UPDATES WHICH REQUIRE CORRECTION SHALL BE IDENTIFIED BY THE PROJECT AND THE APPROPRIATE REQUESTS FOR CORRECTIONS SHALL BE MADE IN AN EXPEDITED MANNER AT THE EARLIEST AVAILABLE OPPORTUNITY.
- 24. IT SHALL BE NOTED THAT THESE PLANS HAVE BEEN GENERATED USING LARGELY AUTOMATED SOFTWARE SYSTEMS. WHILE THE DRAWINGS ARE INTENDED TO ACCOUNT FOR ALL REQUIRED BUILDING CODES, LOCAL ZONING AND PLANNING CODES, AND SITE SPECIFIC ISSUES, MATERIAL OMISSIONS OR INACCURACIES MAY EXIST. THEREFORE, IT IS THE RESPONSIBILITY OF THE PROJECT CONTACT TO VERIFY THE ACCURACY AND COMPLETENESS OF THESE PLANS PRIOR TO SUBMISSION FOR PLANNING AND BUILDING APPROVAL, THE COMMENCEMENT OF PROJECT CONSTRUCTION AND DURING CONSTRUCTION. WHEN INACCURACIES OR OMISSIONS ARE FOUND BY THE PROJECT CONTACT, UPDATES AND OR ADDITIONS TO THE PLANS SHOULD BE MADE TO REMEDY THEM.
- 25. PROJECT CONTACT IS RESPONSIBLE FOR PREPARING AN OPERATION AND MAINTENANCE MANUAL. THE MANUAL SHALL BE AVAILABLE TO THE BUILDING OCCUPANT.



NOTES: PRELIMINARY DESIGNS, NOT FOR CONSTRUCTION.

	Revisions		
No.	Description	Dat	

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226 Harben Cir Marina Ca 93933

HARBEN
APARTMENTS
SCHEMATIC DESIGN

G0.2

PROJECT NOTES

NOTES:

1. ALL DISTANCES SHOWN HEREON ARE EXPRESSED IN FEET AND DECIMALS THEREOF.

BOUNDARY LOCATIONS SHOWN HEREON WERE DETERMINED WITH THE BENEFIT OF A FIELD SURVEY SUPPLEMENTED BY RECORD DATA. ALL BOUNDARY DATA SHOWN ARE FROM THE RECORDS. THIS IS NOT A BOUNDARY SURVEY.

3. ELEVATIONS SHOWN ARE BASED ON AN ASSUMED DATUM THAT APPROXIMATES THE

5. TREE TYPES ARE INDICATED WHEN KNOWN. DIAMETERS OF TREES ARE SHOWN IN INCHES. TREES SMALLER THAN 5" ARE NOT SHOWN.


6. LOCATION OF ADJACENT BUILDINGS ARE TRACED FROM IMAGERY AND ARE


ELEVATION = 66.00 FEET (APPROX. NAVD88)

4. CONTOUR INTERVAL = ONE FOOT.

APPROXIMATE.

NORTH AMERICAN VERTICAL DATUM OF 1988 (NAVD88). PROJECT BENCHMARK IS A MAG. NAIL & STAINLESS STEEL WASHER STAMPED "CENTRAL COAST SURVEYORS" SET IN THE A.C. PAVEMENT OF HARBEN CIRCLE, AS SHOWN.

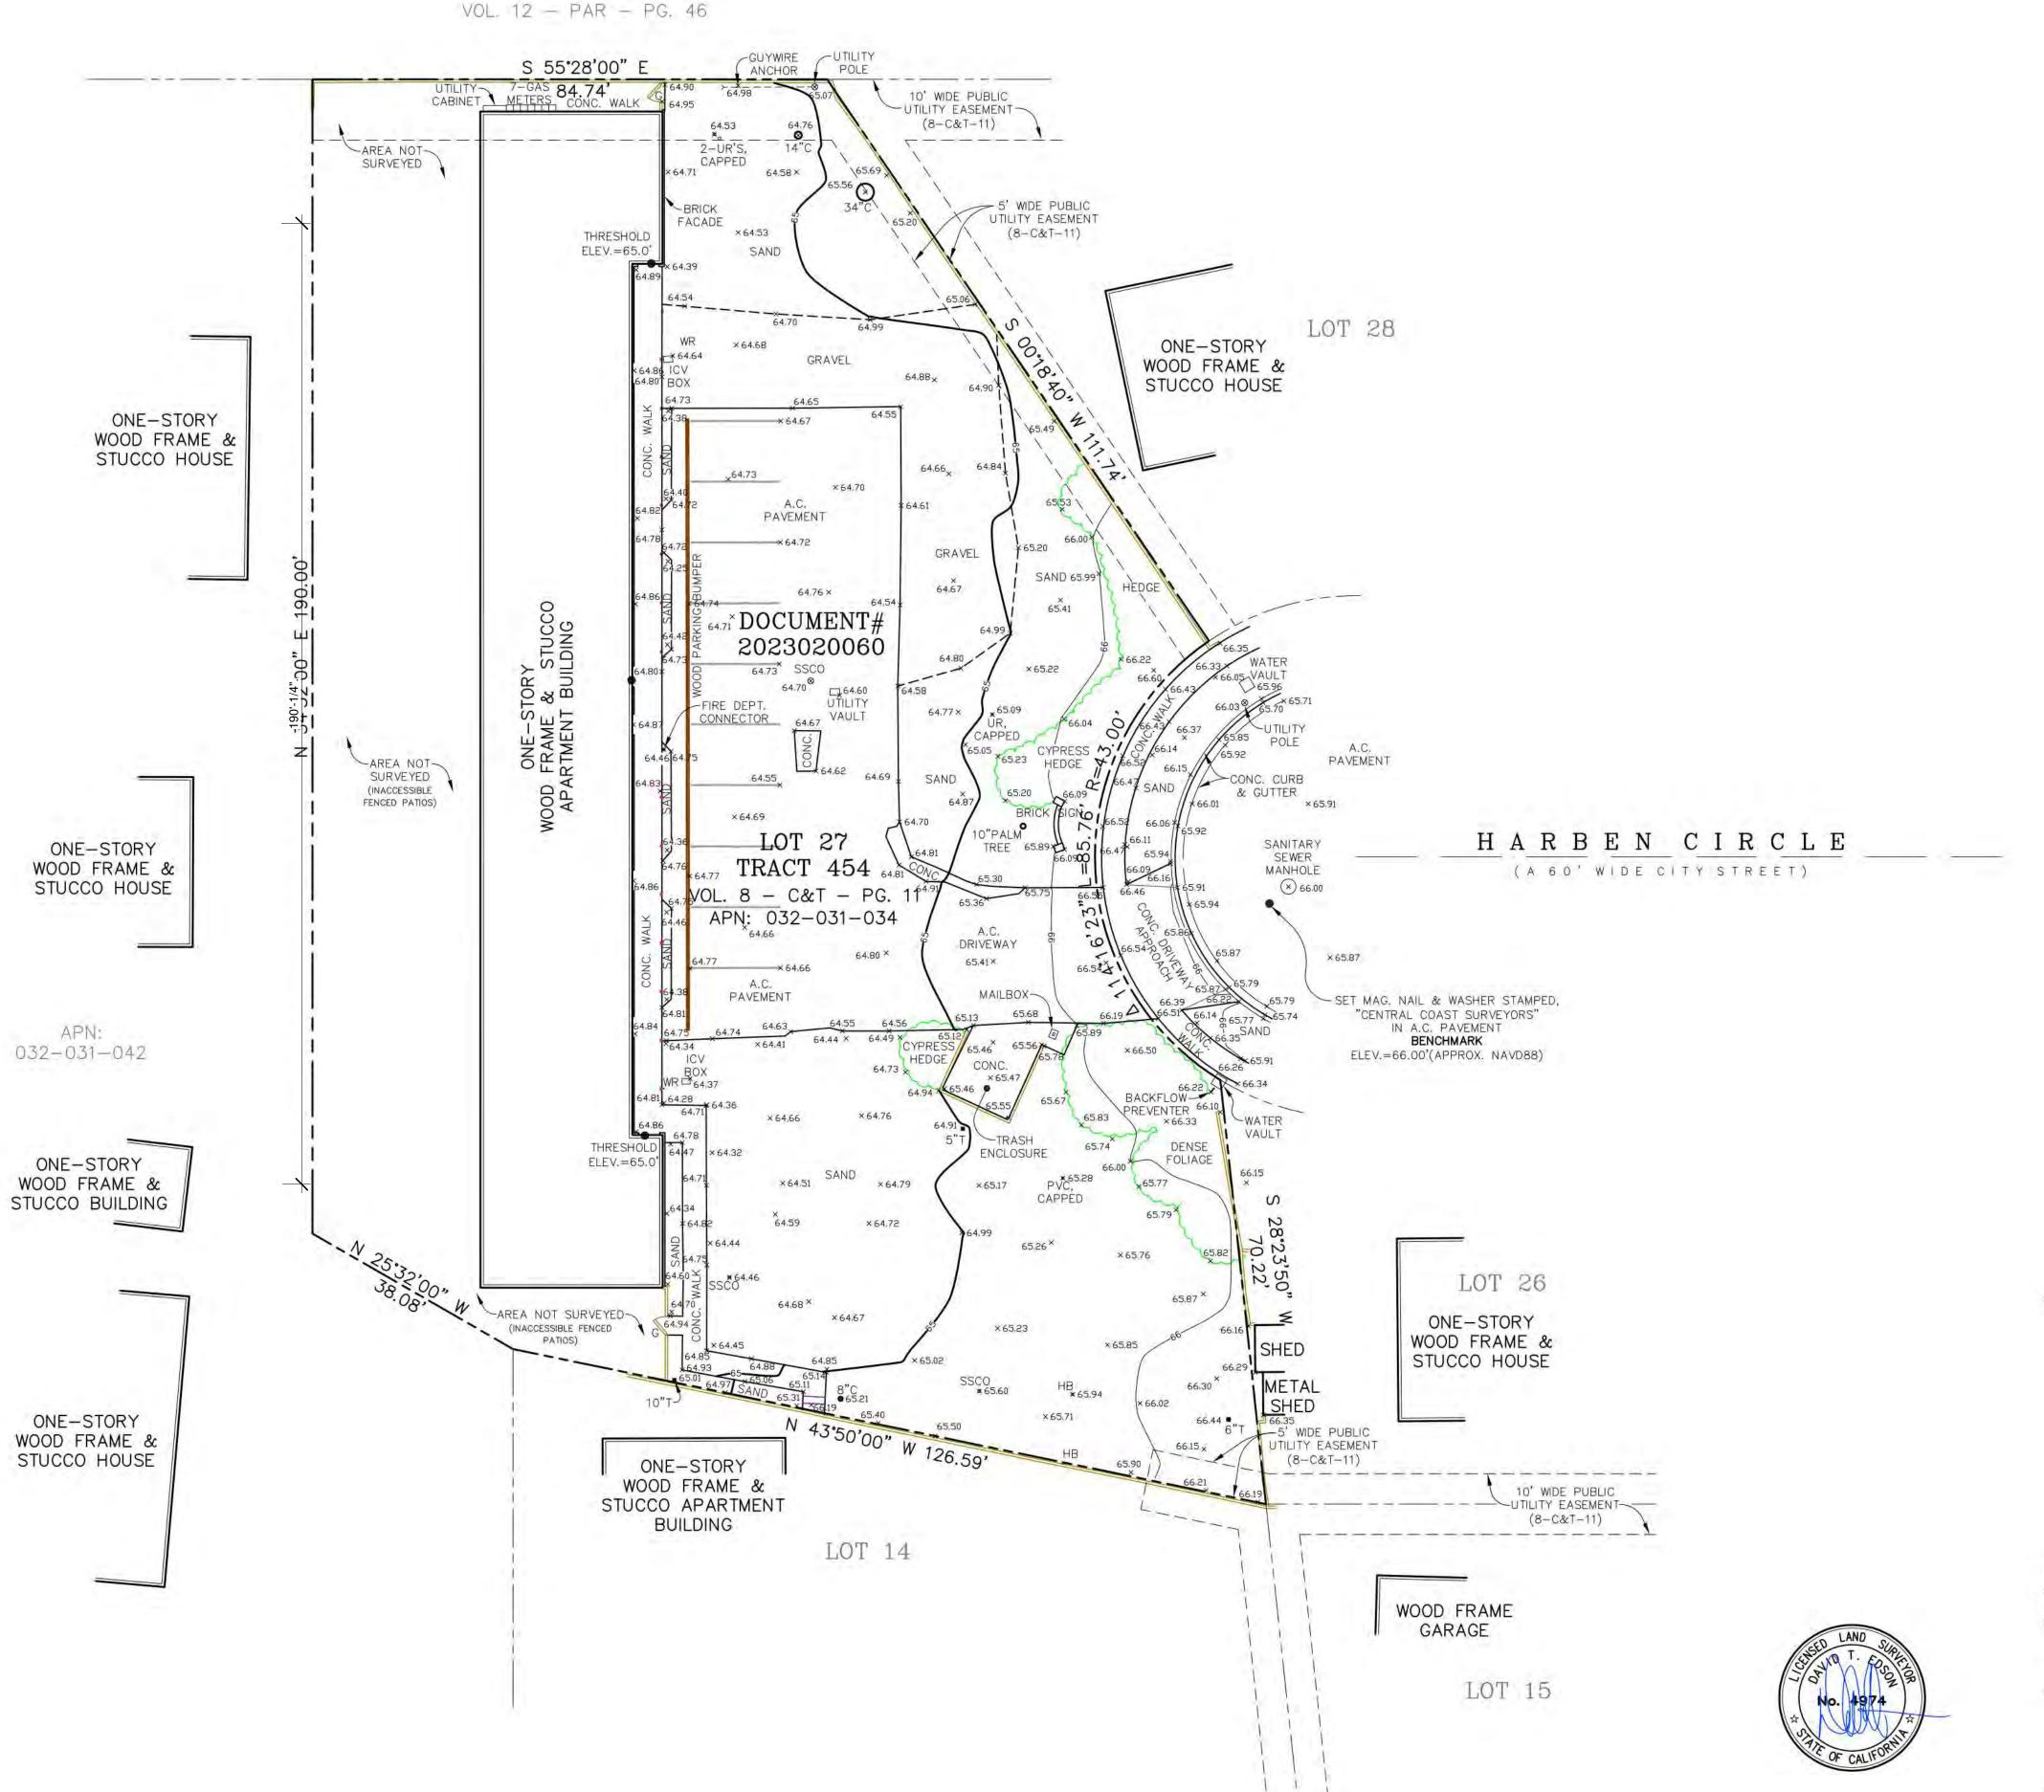

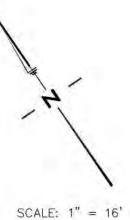

LEGEND:

HB	HOSEBIB
G	GATE
ICV	IRRIGATION CONTROL VALVE
SSCO	SANITARY SEWER CLEANOUT
UR	UTILITY RISER
WR	WATER RISER
*	DENOTES A WOOD PILLAR
8"T	DENOTES A 8" DIA. TREE (TYP.)
8"C	DENOTES A 8" DIA. CYPRESS TREE (TYP.)
	DENOTES PROTRACTED BOUNDARY
	DENOTES A STEP
	DENOTES A PARK STRIPE
	DENOTES A WOOD FENCE

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226 Harben Cir Marina Ca 93933

HARBEN **APARTMENTS** SCHEMATIC DESIGN SURVEY

G1.0

TOPOGRAPHIC MAP

OF A PORTION OF THE PARCEL DESCRIBED IN DOCUMENT# 2023020060 BEING ALSO LOT 27 IN TRACT 454 AS SHOWN ON THE MAP, "TRACT NO. 454, DEL PRADO PARK NO. 2..." FILED IN, VOL. 8 - C&T - PG. 11

OFFICIAL RECORDS OF MONTEREY COUNTY

COUNTY OF MONTEREY STATE OF CALIFORNIA


PREPARED FOR

Marina Harben Apartments, LLC

CENTRAL COAST SURVEYORS 5 HARRIS COURT, SUITE N-11 MONTEREY, CALIFORNIA 93940 Phone: (831) 394-4930 Fax: (831) 394-4931

SCALE: 1" = 16'JOB No. 23-89 SEPTEMBER 2023 PREPARER: LLJS

APN: 032-031-034

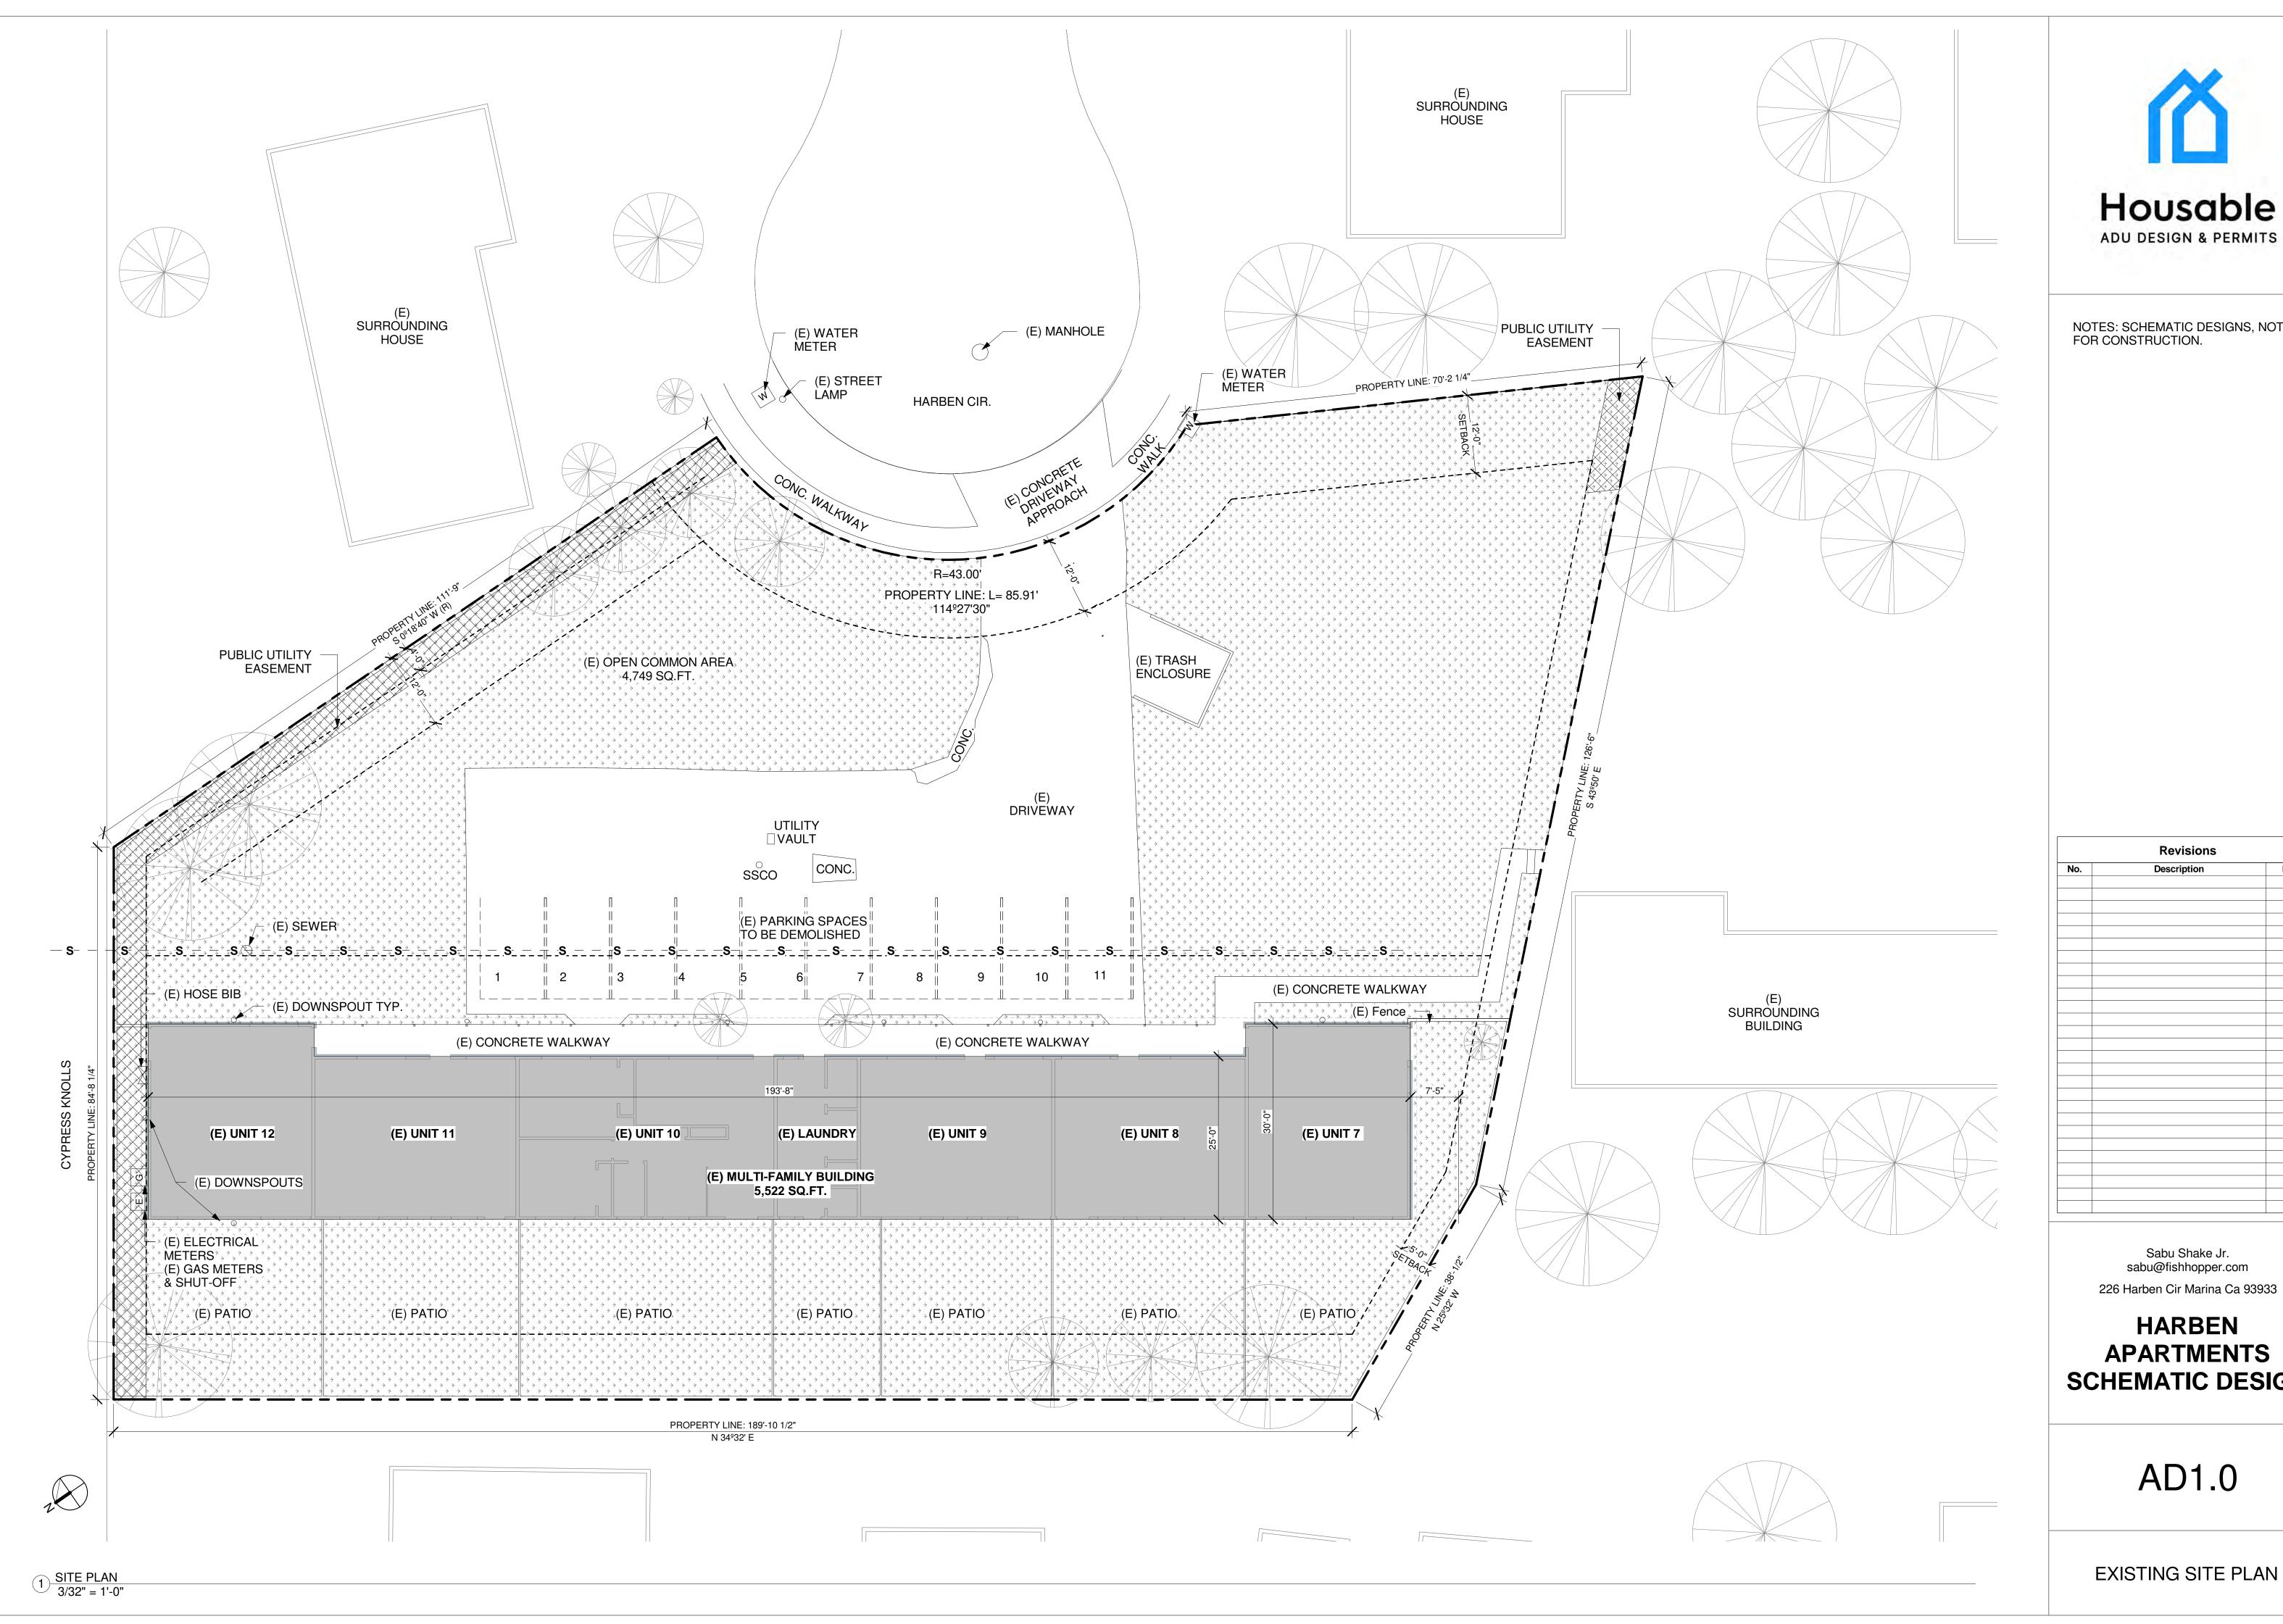



	Revisions			
No.	Description	Date		
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HARBEN APARTMENTS SCHEMATIC DESIGN

AD1.0








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HARBEN APARTMENTS SCHEMATIC DESIGN

AD2.0

EXISTING FLOOR PLANS



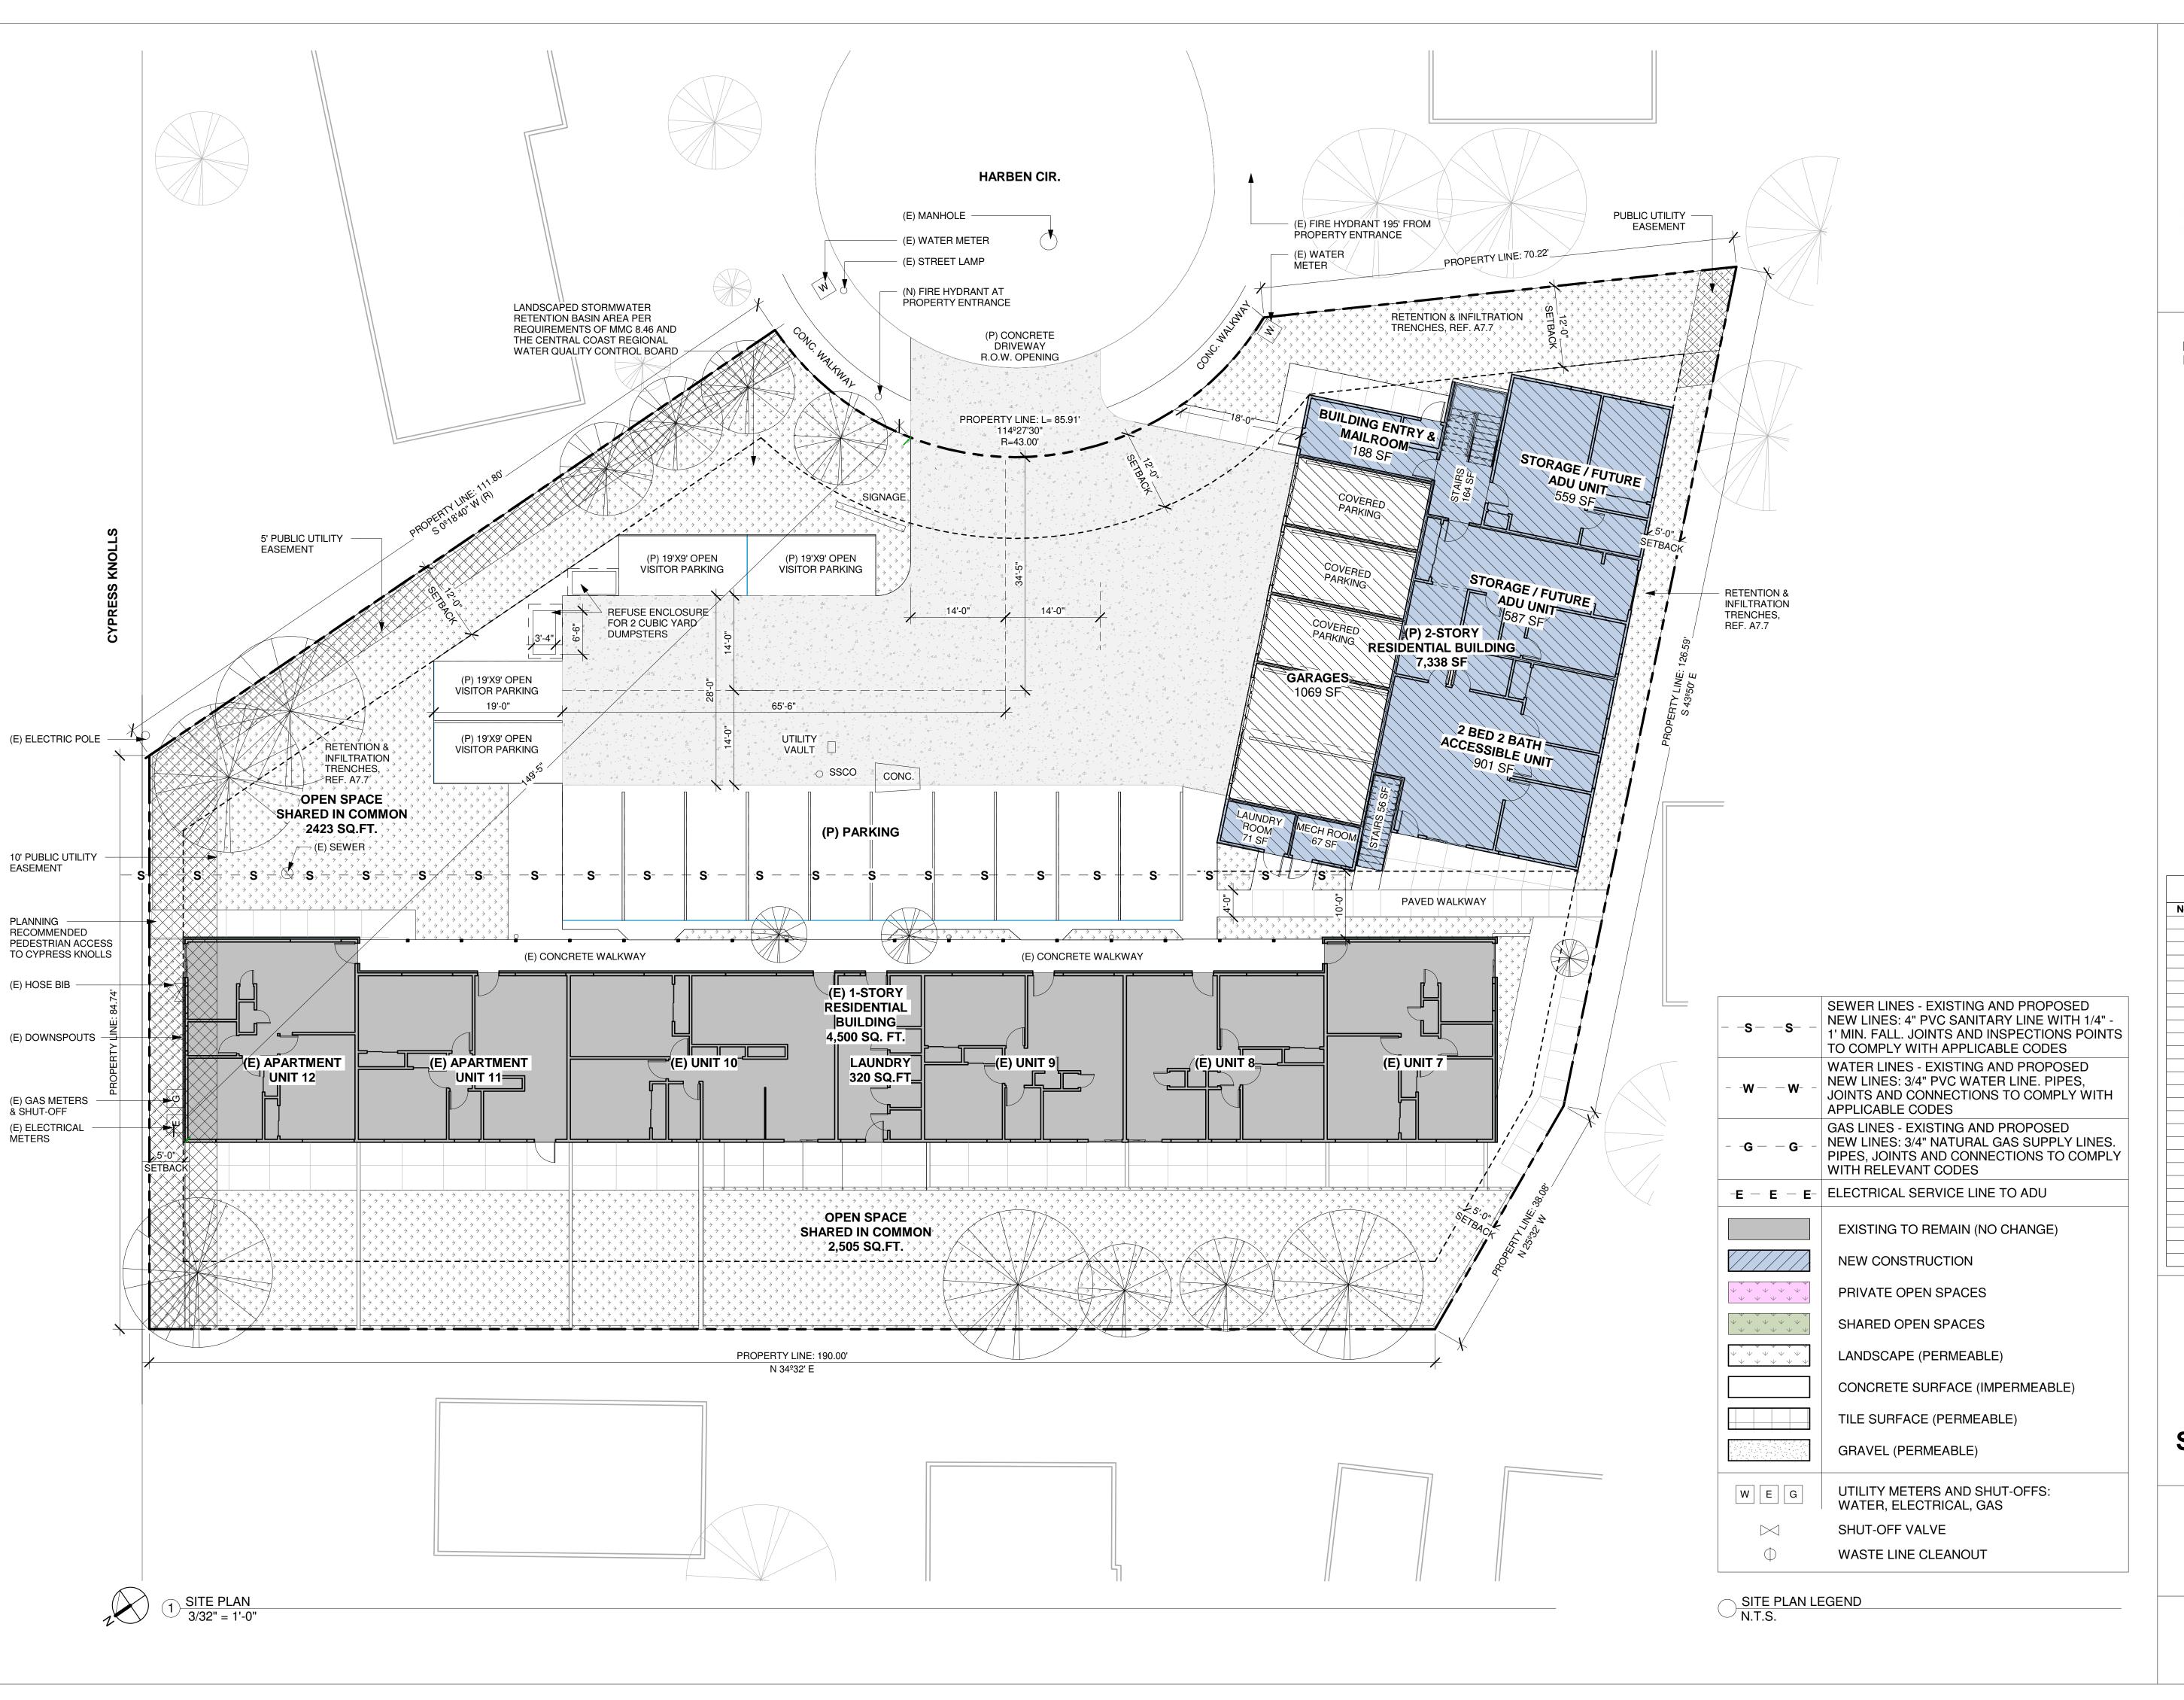


No.	Description	Date

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HARBEN APARTMENTS SCHEMATIC DESIGN

A1.0

PROPOSED SITE PLAN



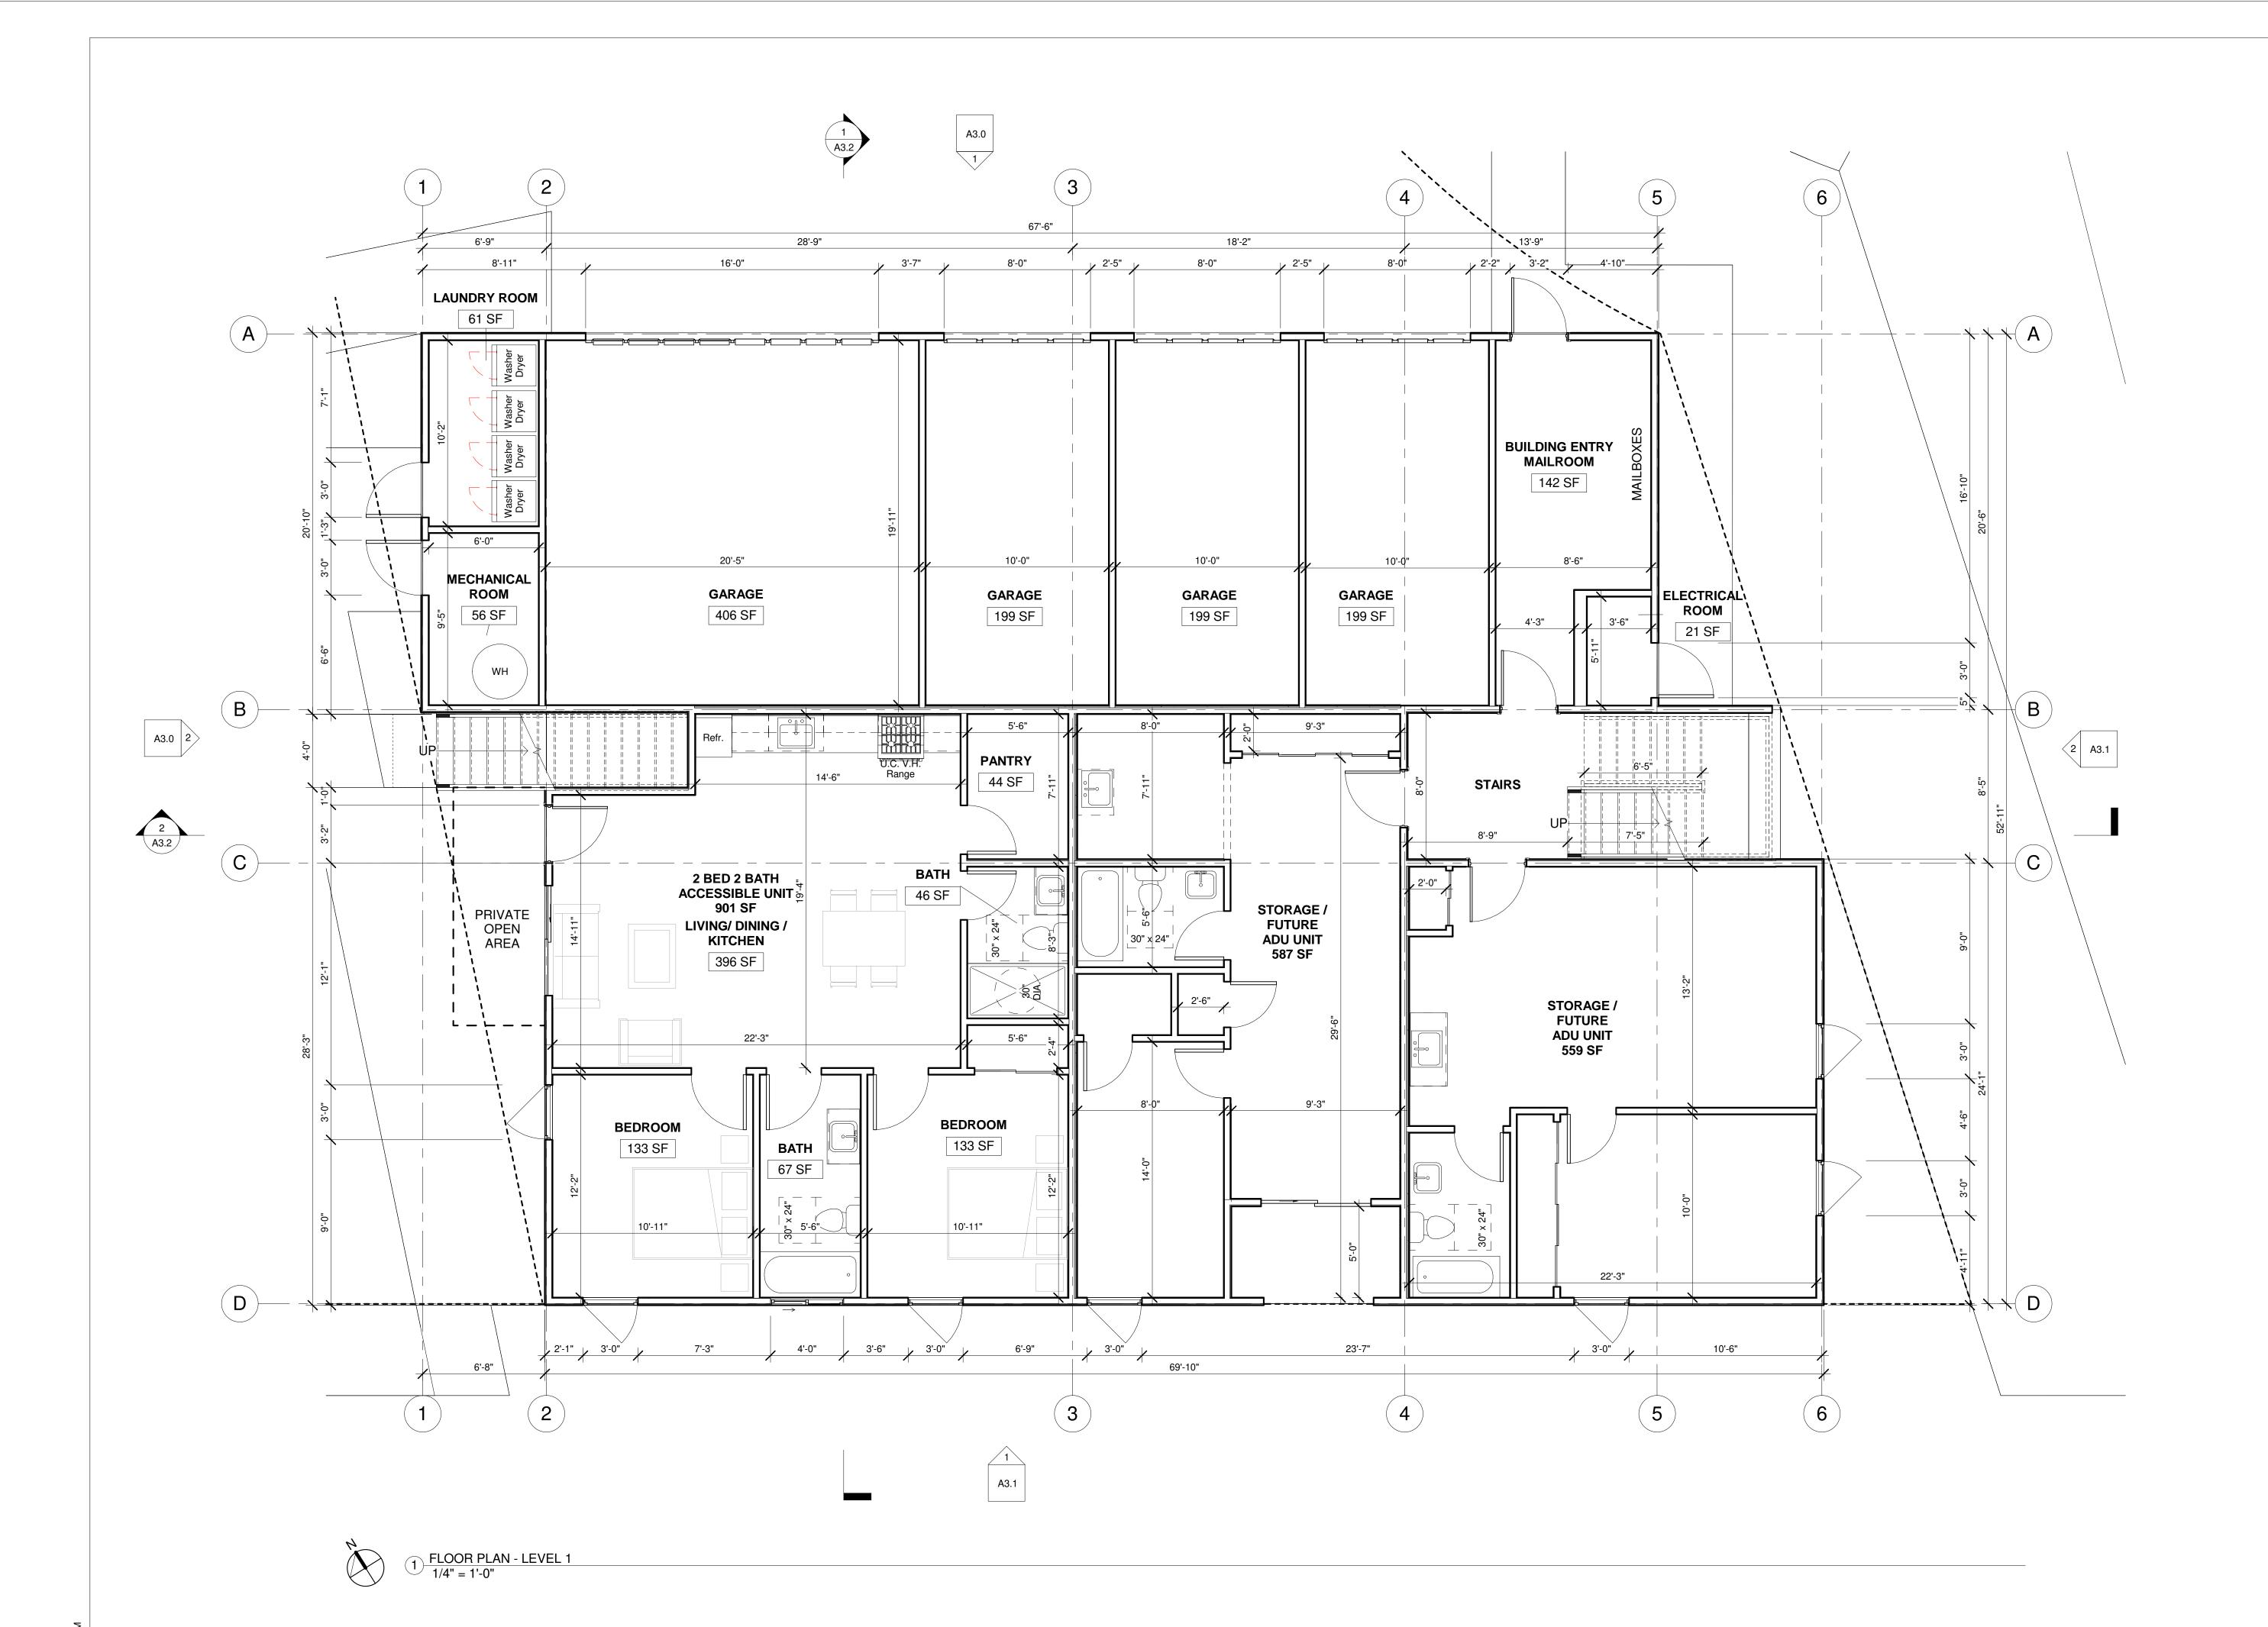




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HARBEN APARTMENTS SCHEMATIC DESIGN

A2.0

PROPOSED FLOOR PLAN -LEVEL 1



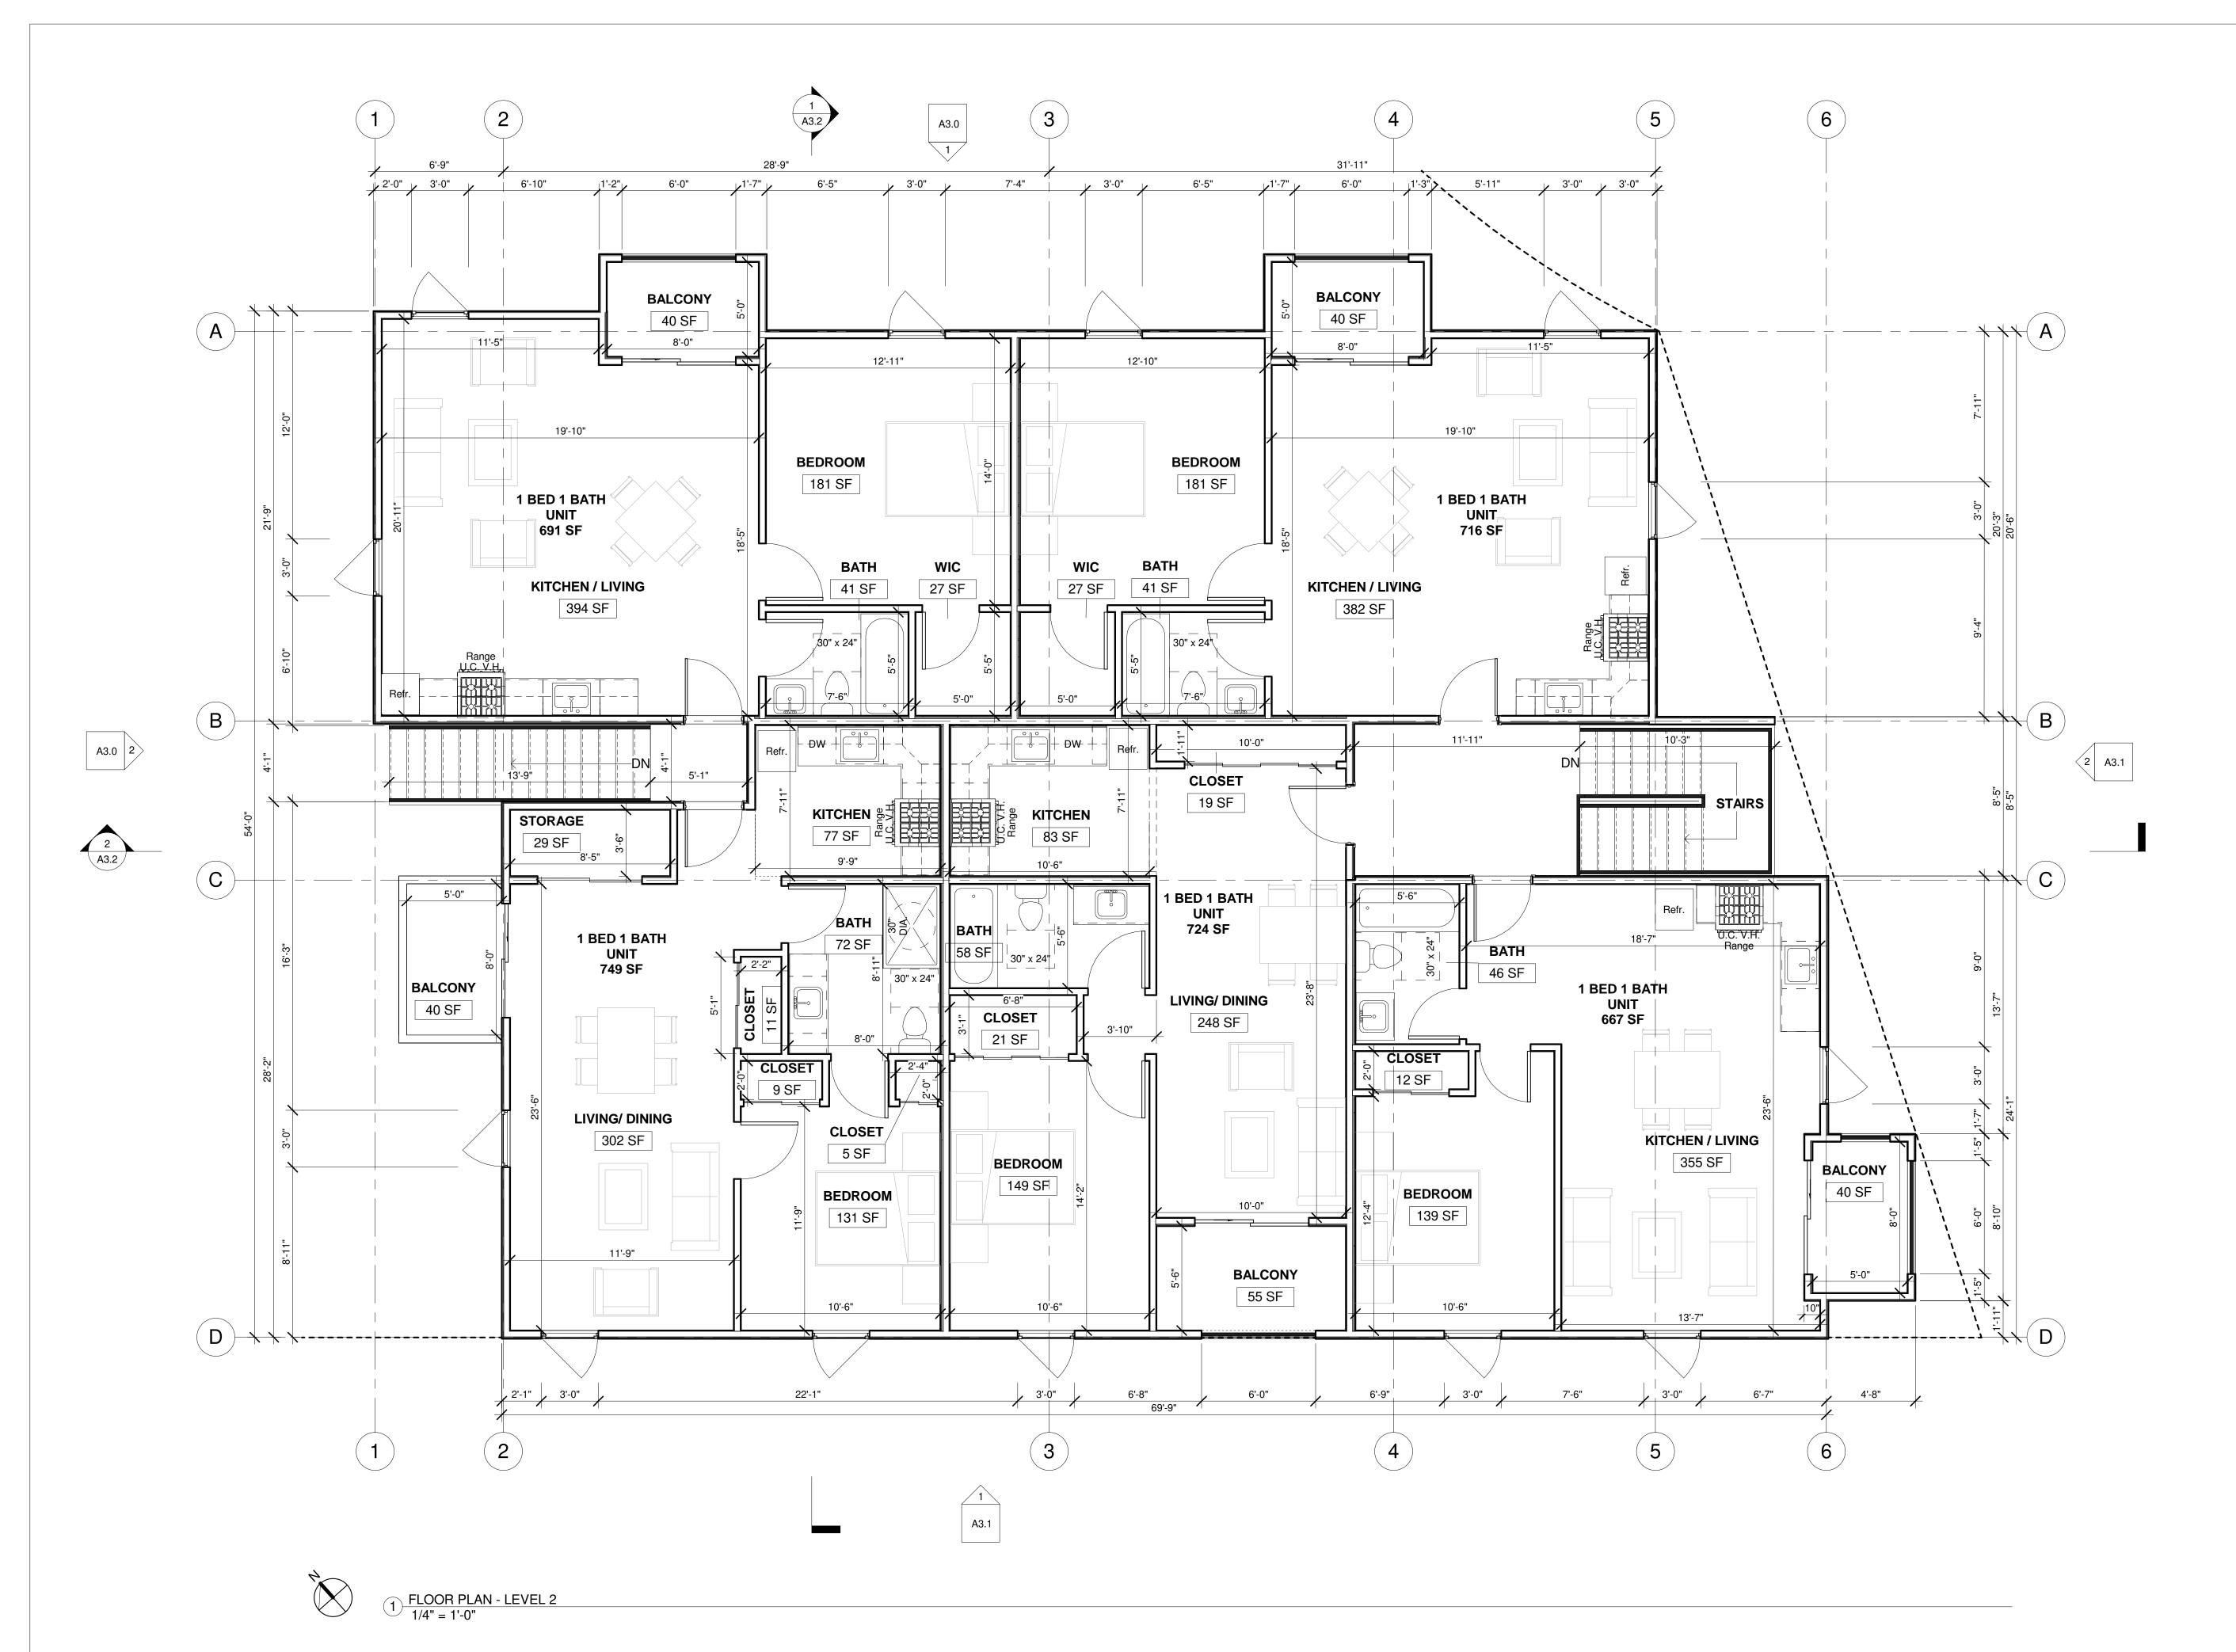




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A2.1

PROPOSED FLOOR PLAN -LEVEL 2



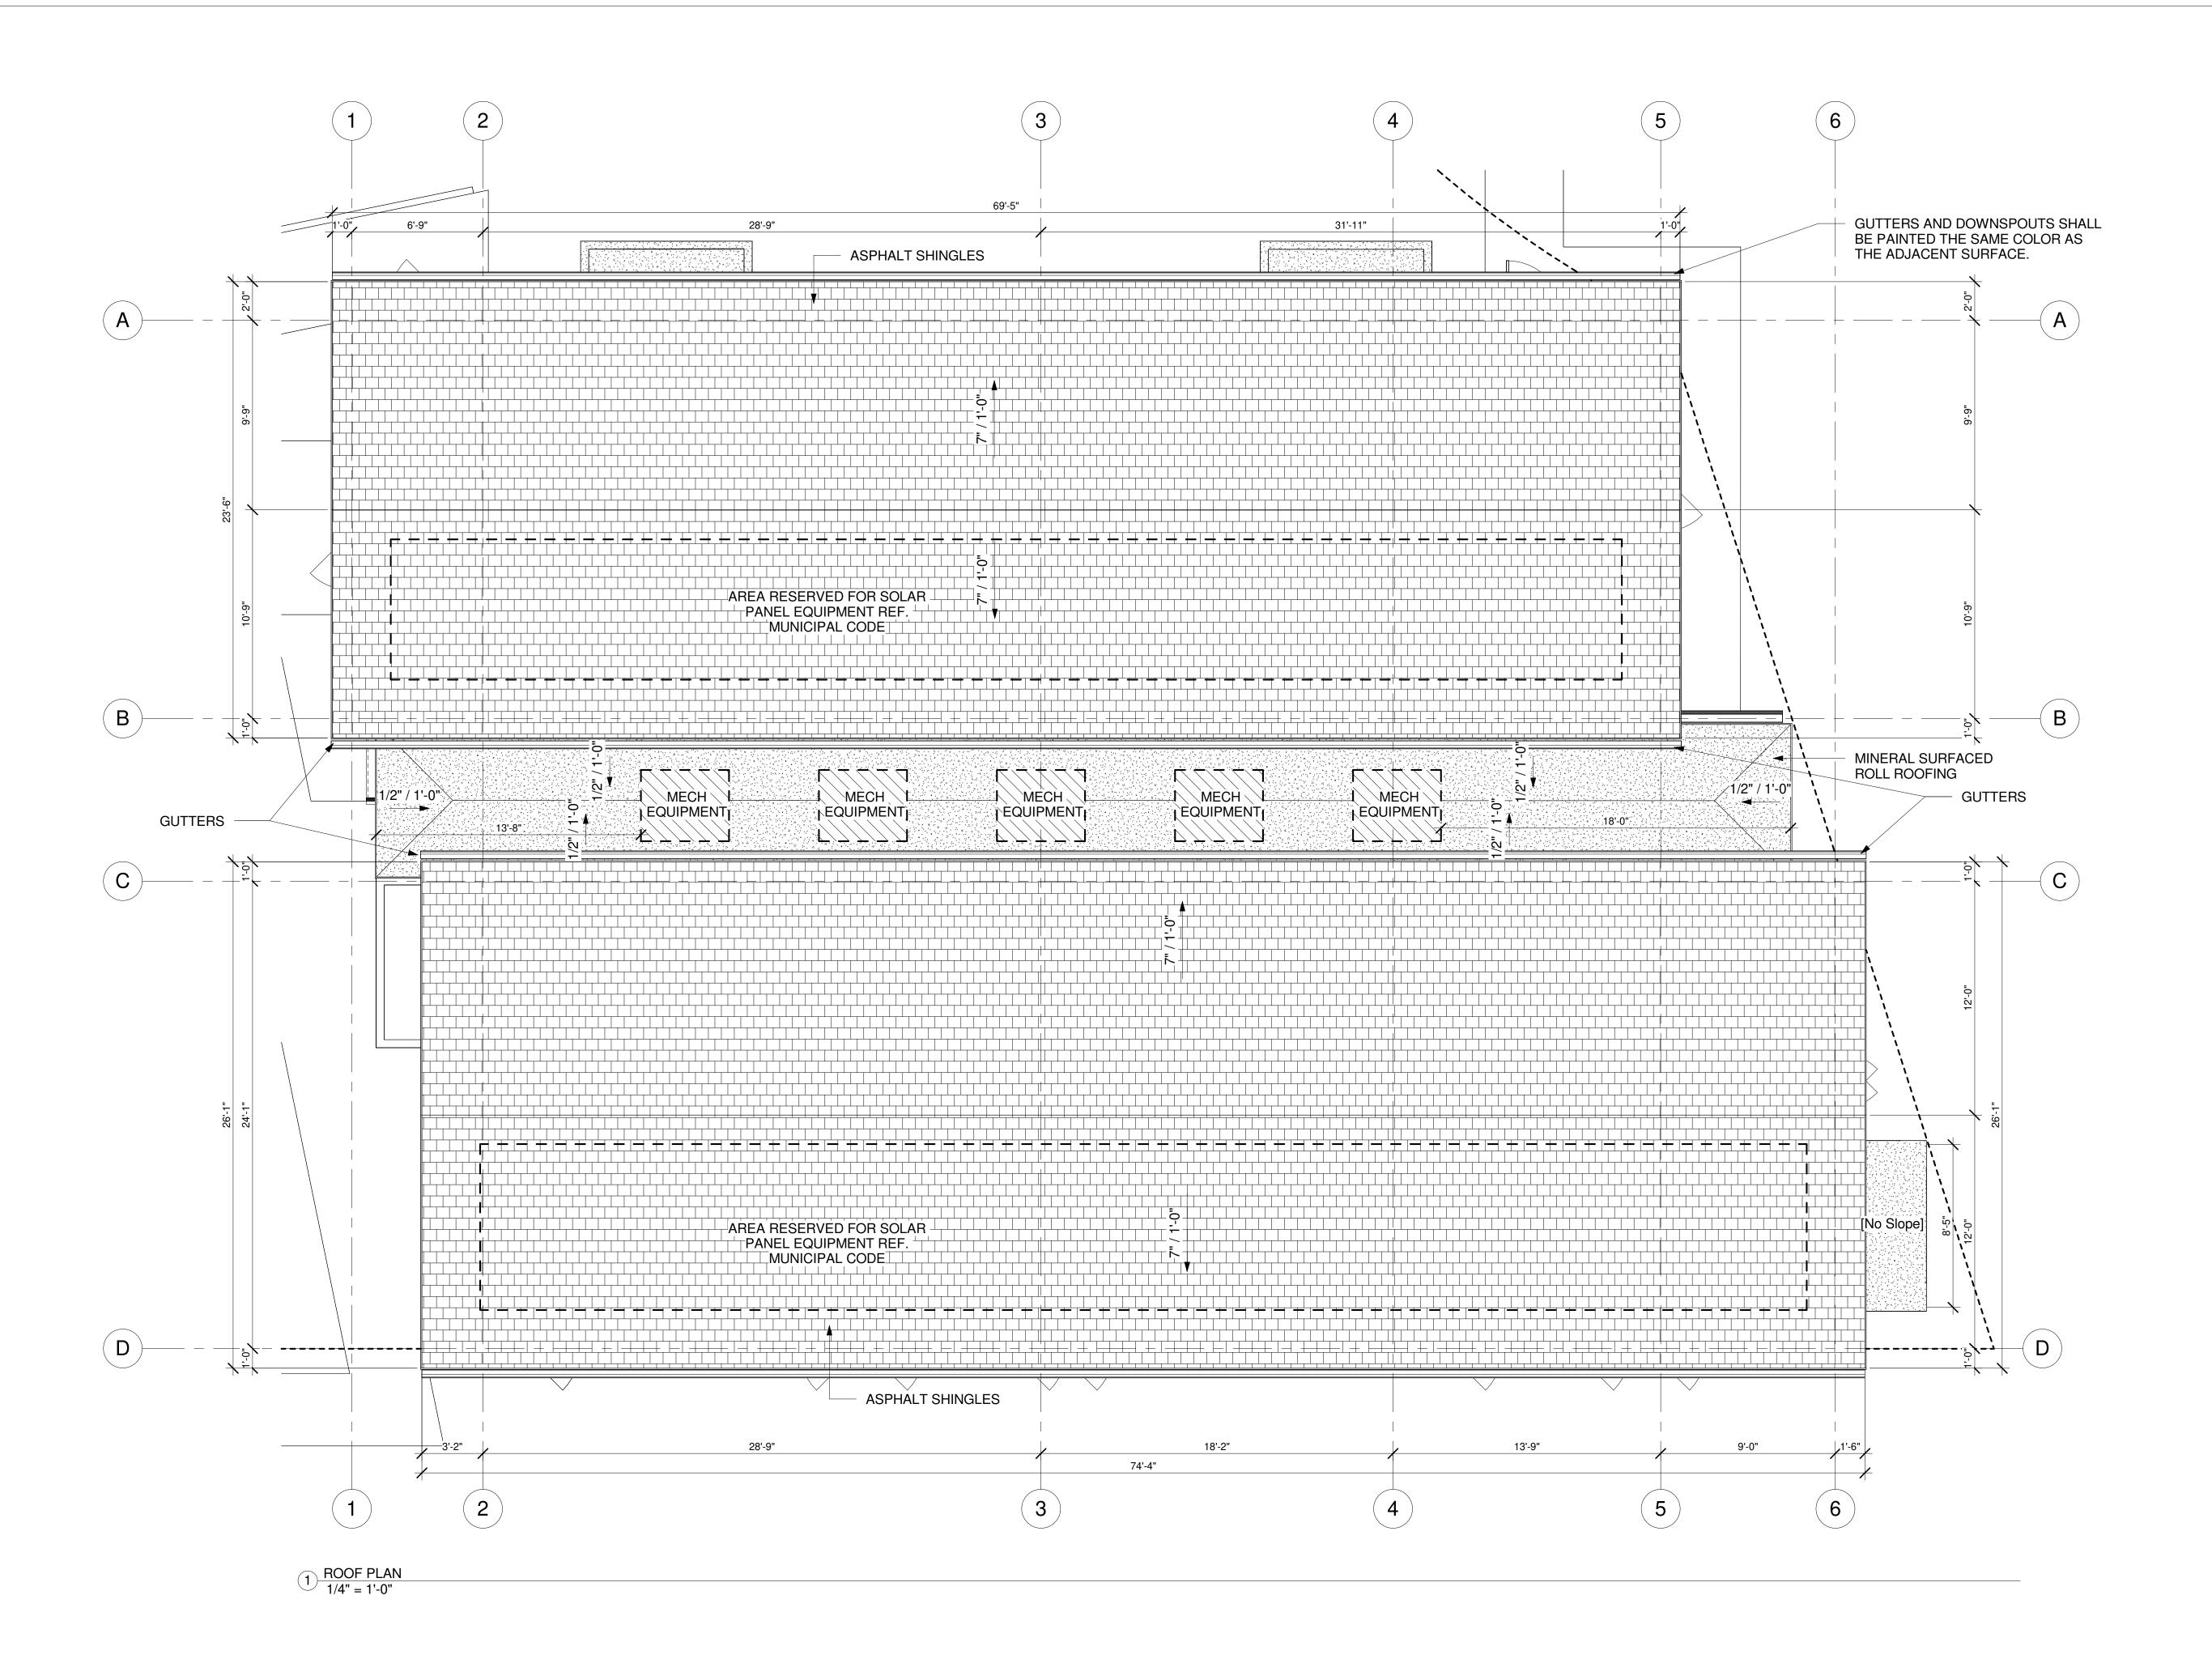

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HARBEN APARTMENTS SCHEMATIC DESIGN

A2.2

PROPOSED ROOF PLAN






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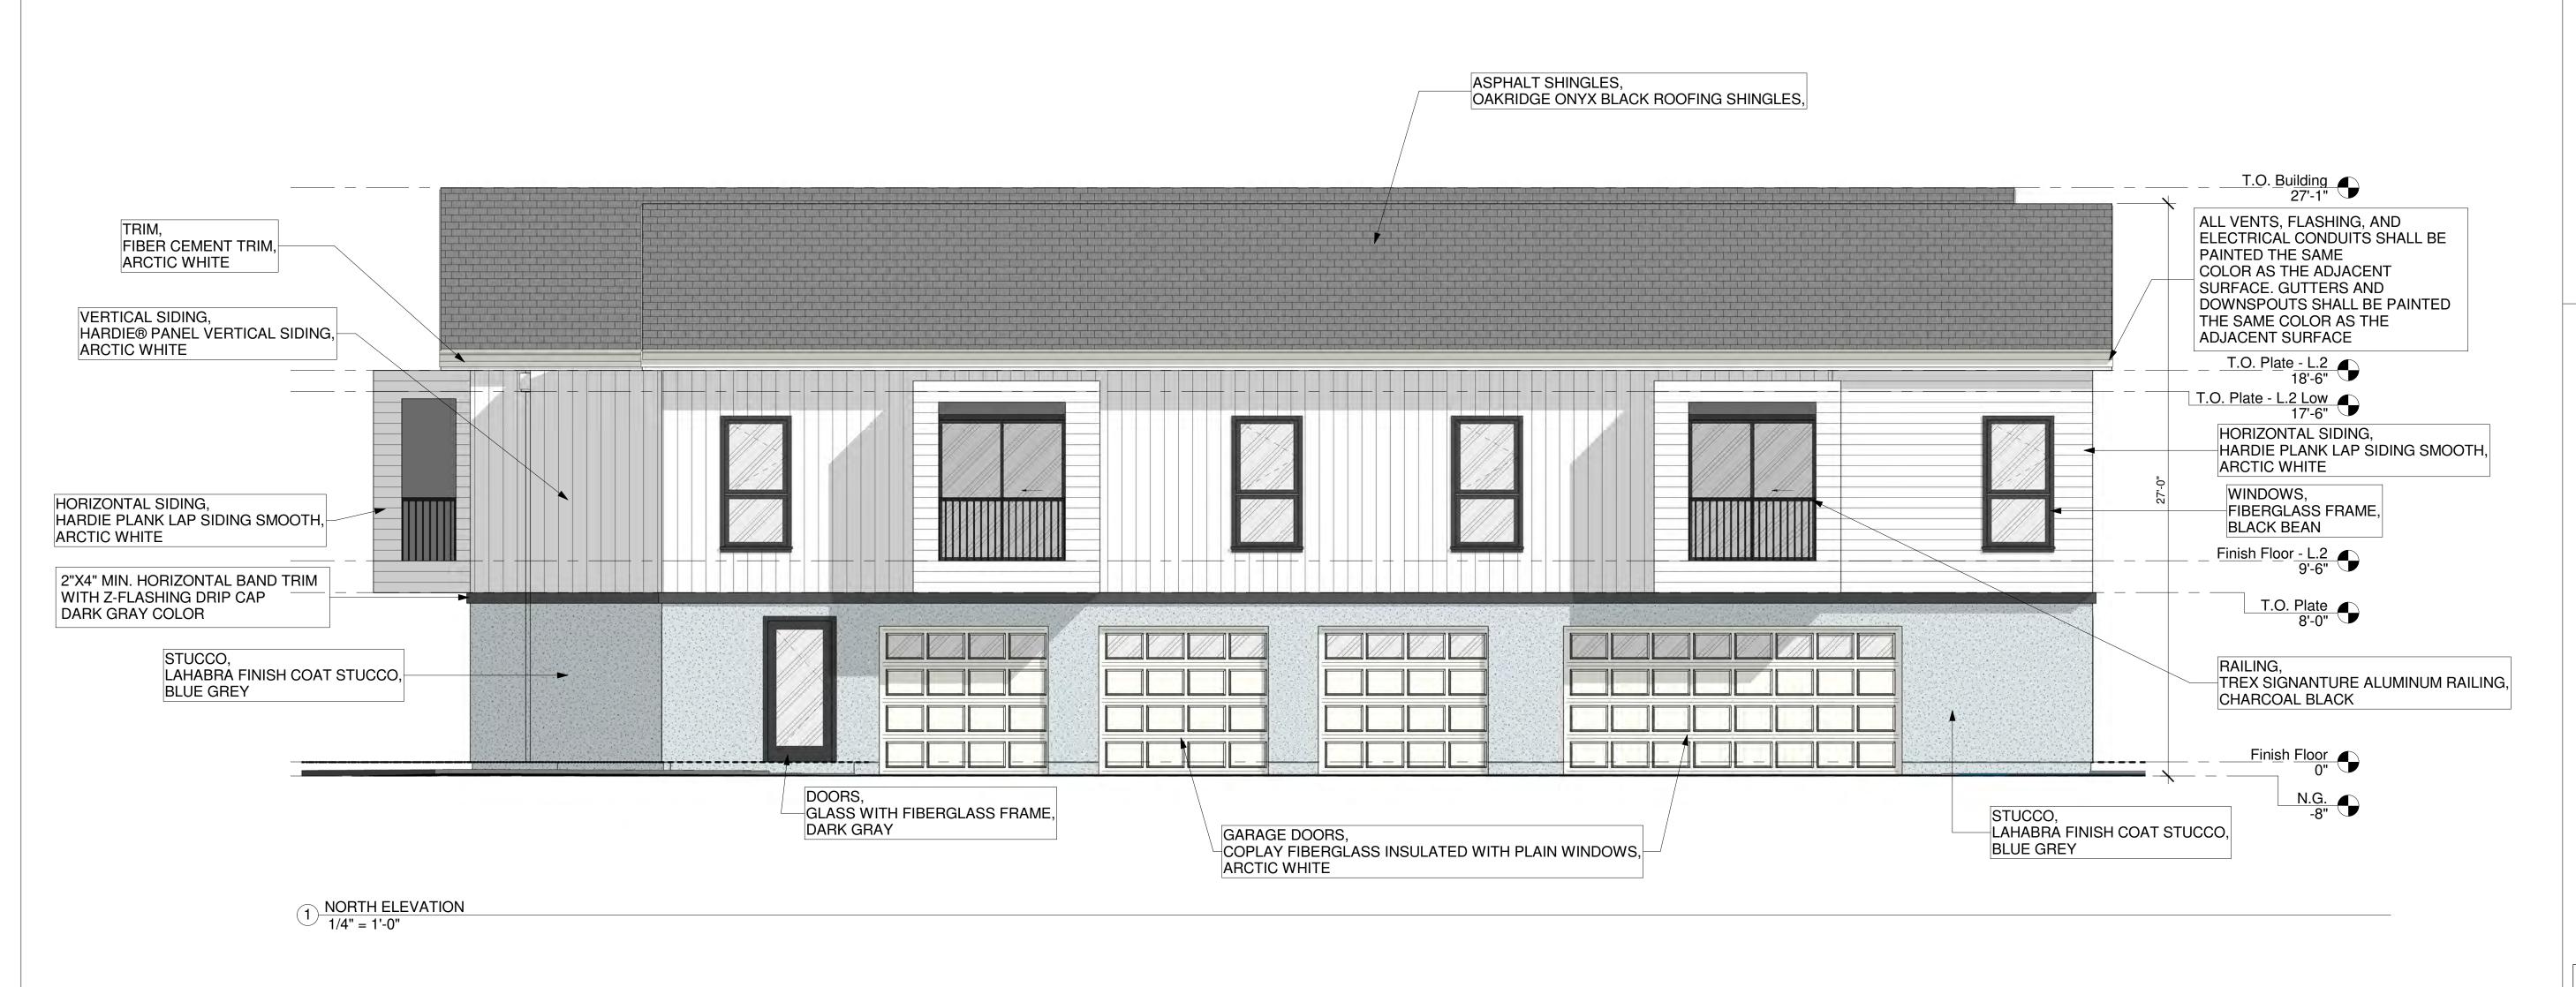
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A2.4

CONVERSION FLOOR PLAN - LEVEL 1



1) FLOOR PLAN - FUTURE ADUS- LEVEL 1 1/4" = 1'-0"

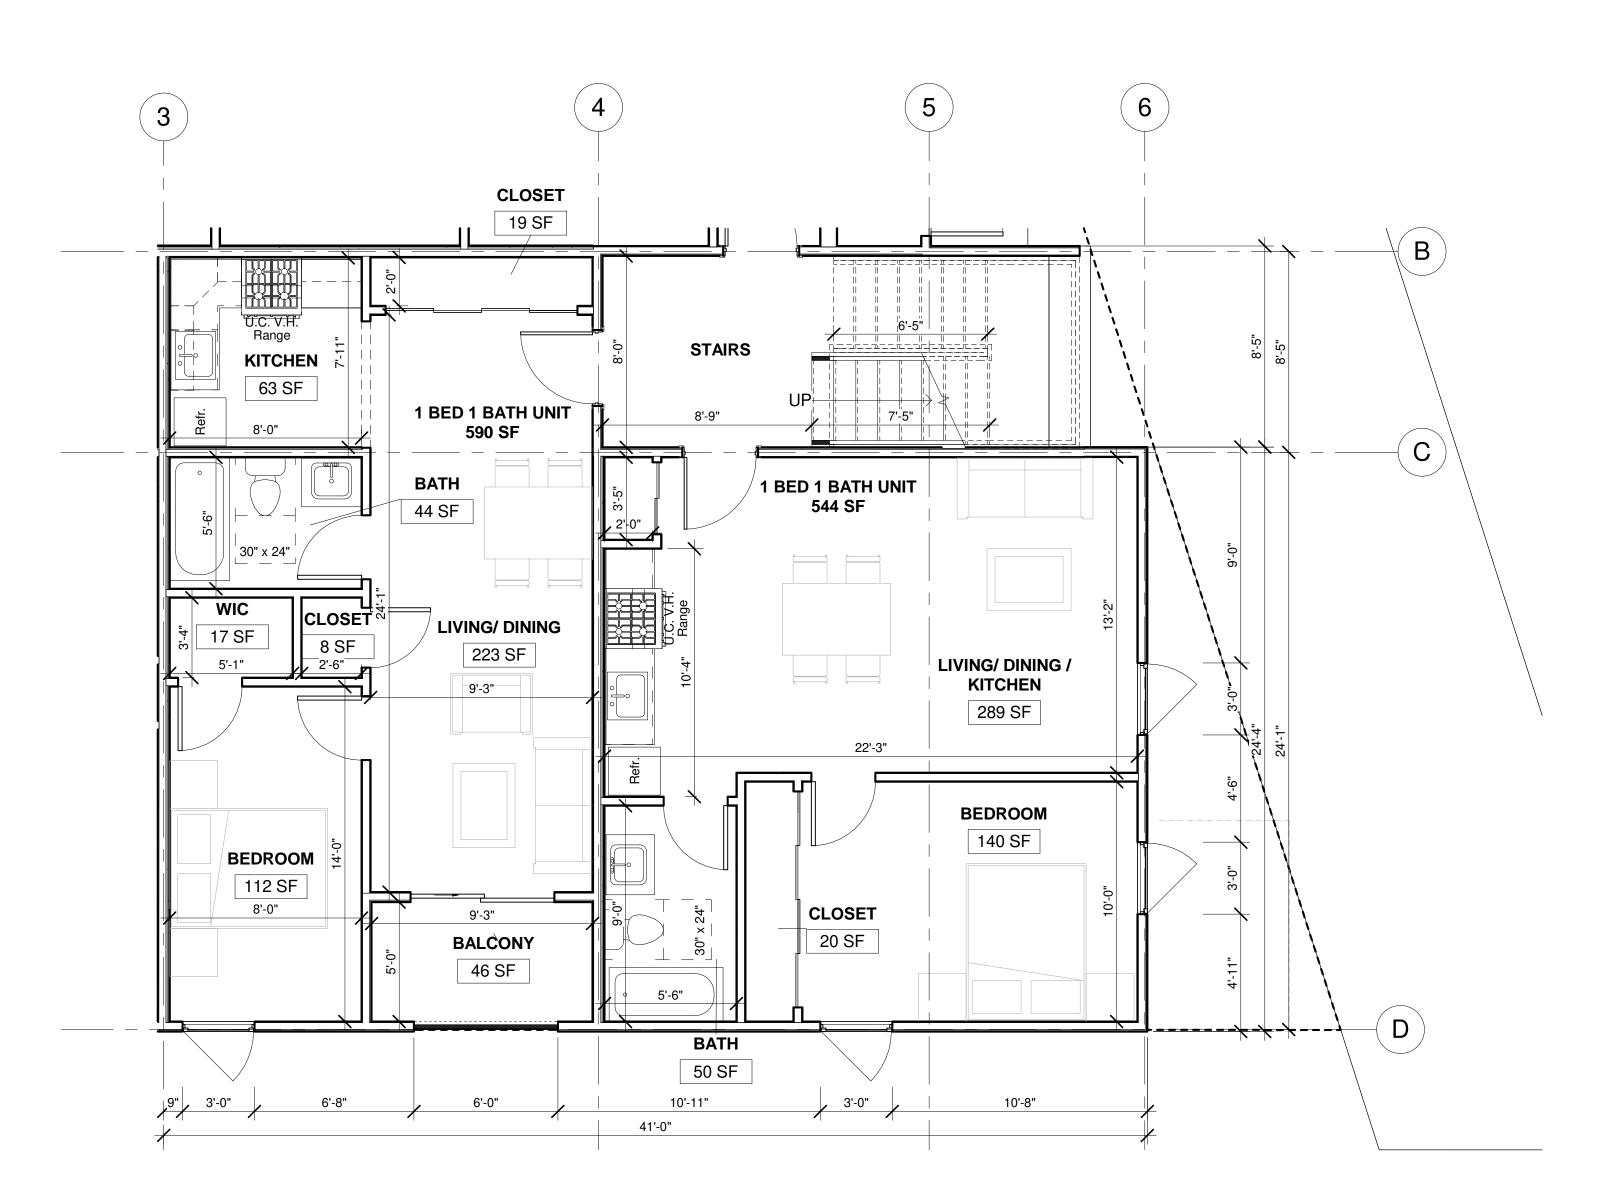



WEST ELEVATION
1/4" = 1'-0"



NOTES: SCHEMATIC DESIGNS, NOT FOR CONSTRUCTION.

MATERIAL NOTE:

1. FOR MATERIAL DETAIL SEE SHEET




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HARBEN
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SCHEMATIC DESIGN

A3.0

PROPOSED ELEVATIONS



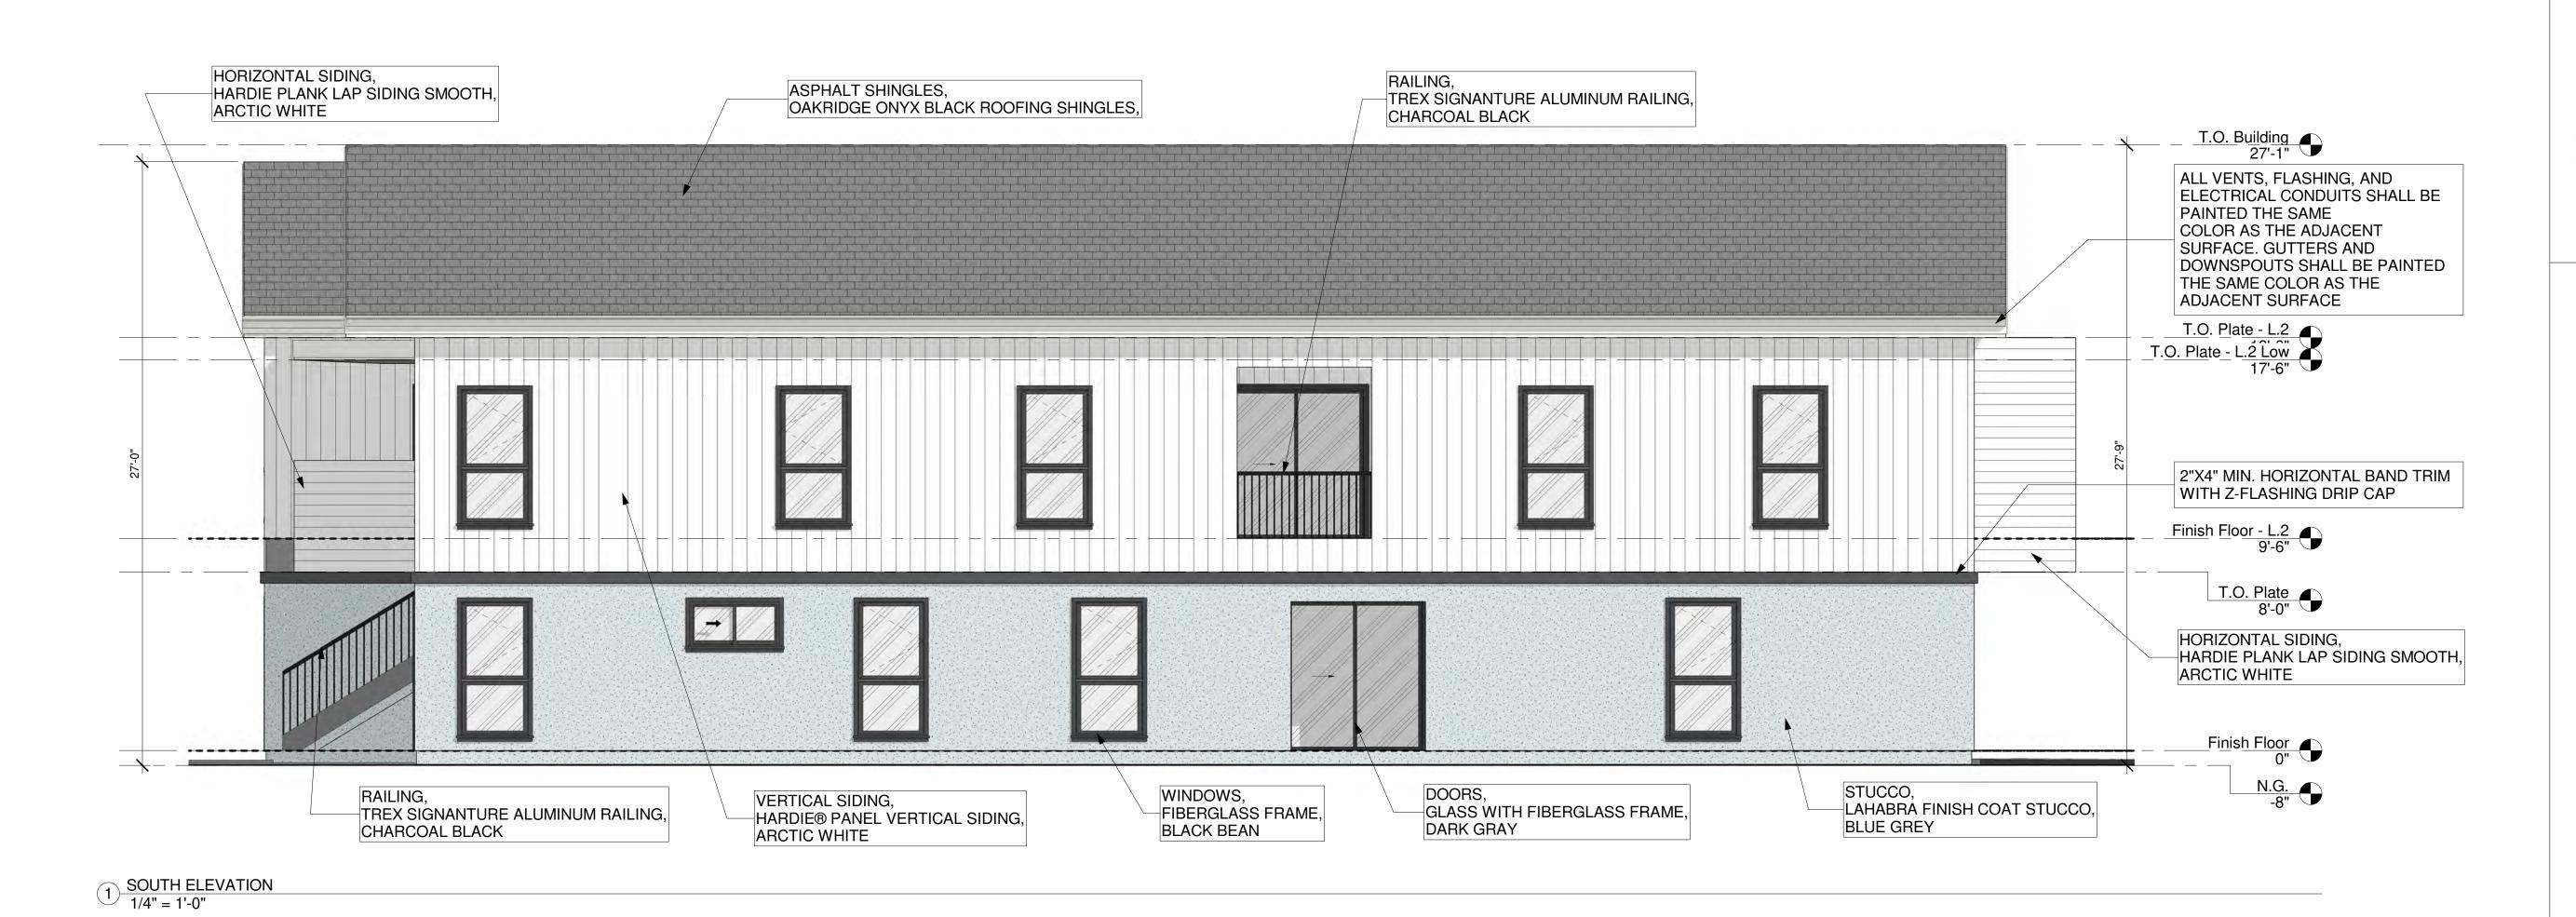



MATERIAL NOTE:
1. FOR MATERIAL DETAIL SEE SHEET
A4.1




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HARBEN APARTMENTS SCHEMATIC DESIGN

A3.1

PROPOSED ELEVATIONS

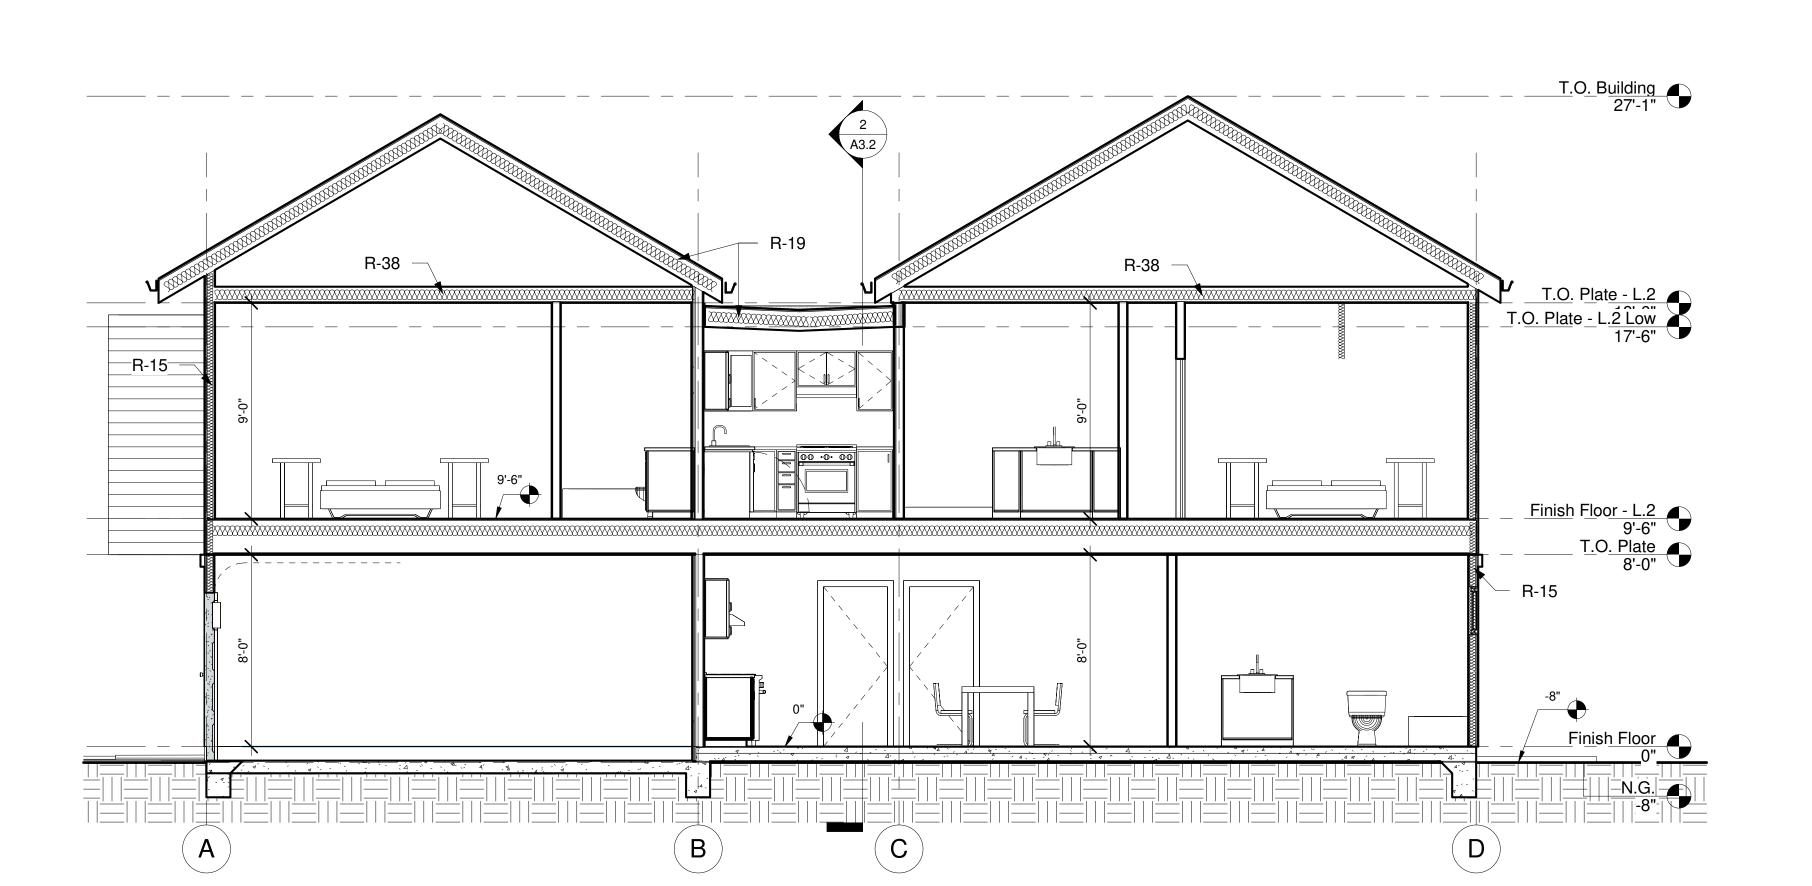

1 SECTION 1 1/4" = 1'-0" LEFT BLANK INTENTIONALLY. THIS SPACE WILL BE USED FOR NOTES TO BE ADDED LATER IN THE DRAFTING PROCESS.

NOTES:



NOTES: SCHEMATIC DESIGNS, NOT FOR CONSTRUCTION.

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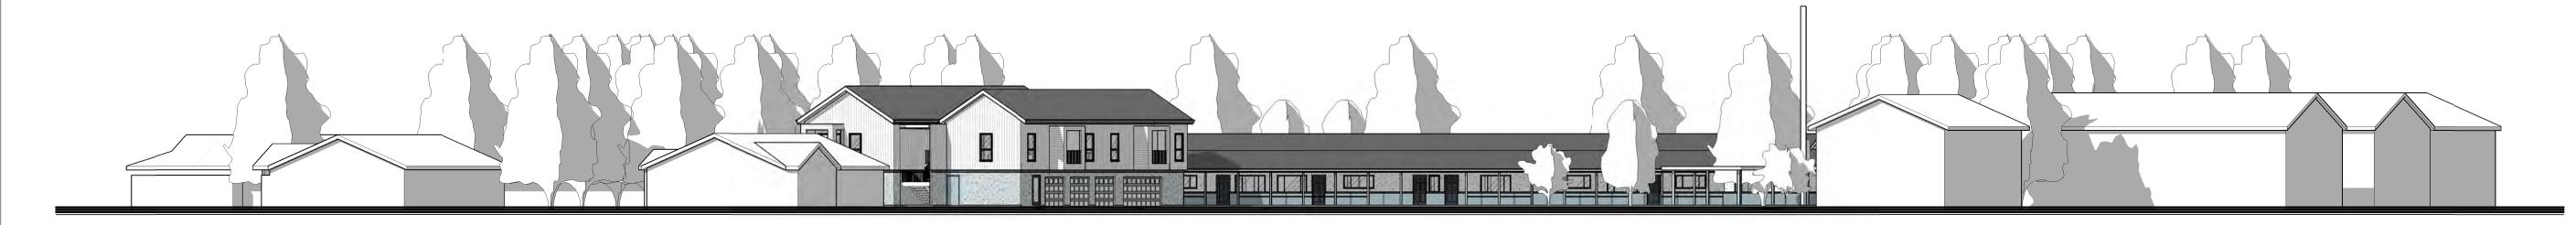
HARBEN APARTMENTS SCHEMATIC DESIGN

A3.2

PROPOSED SECTIONS







1 STREET ELEVATION


Revisions			
No.	Description	Date	


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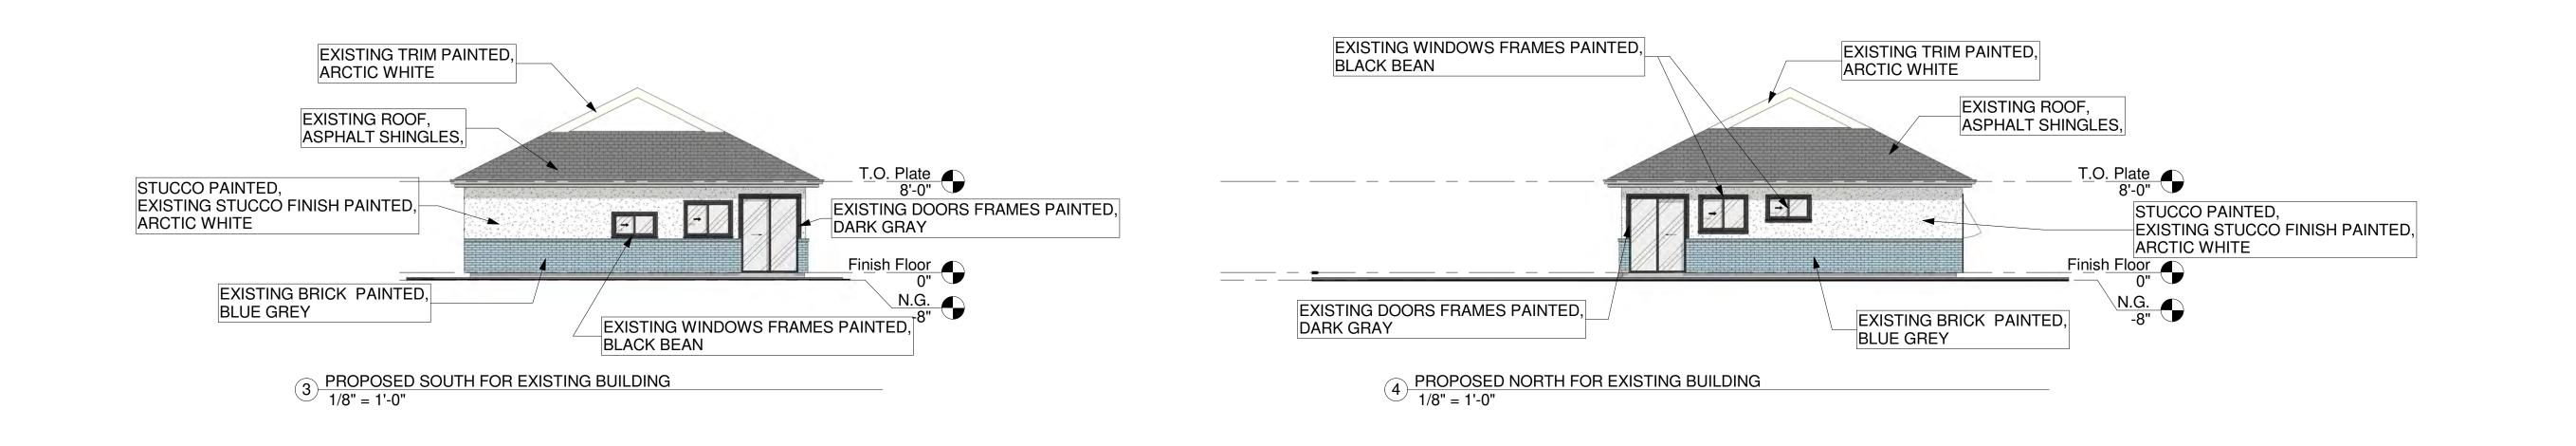
HARBEN APARTMENTS SCHEMATIC DESIGN

A3.3

PROPOSED SITE ELEVATION



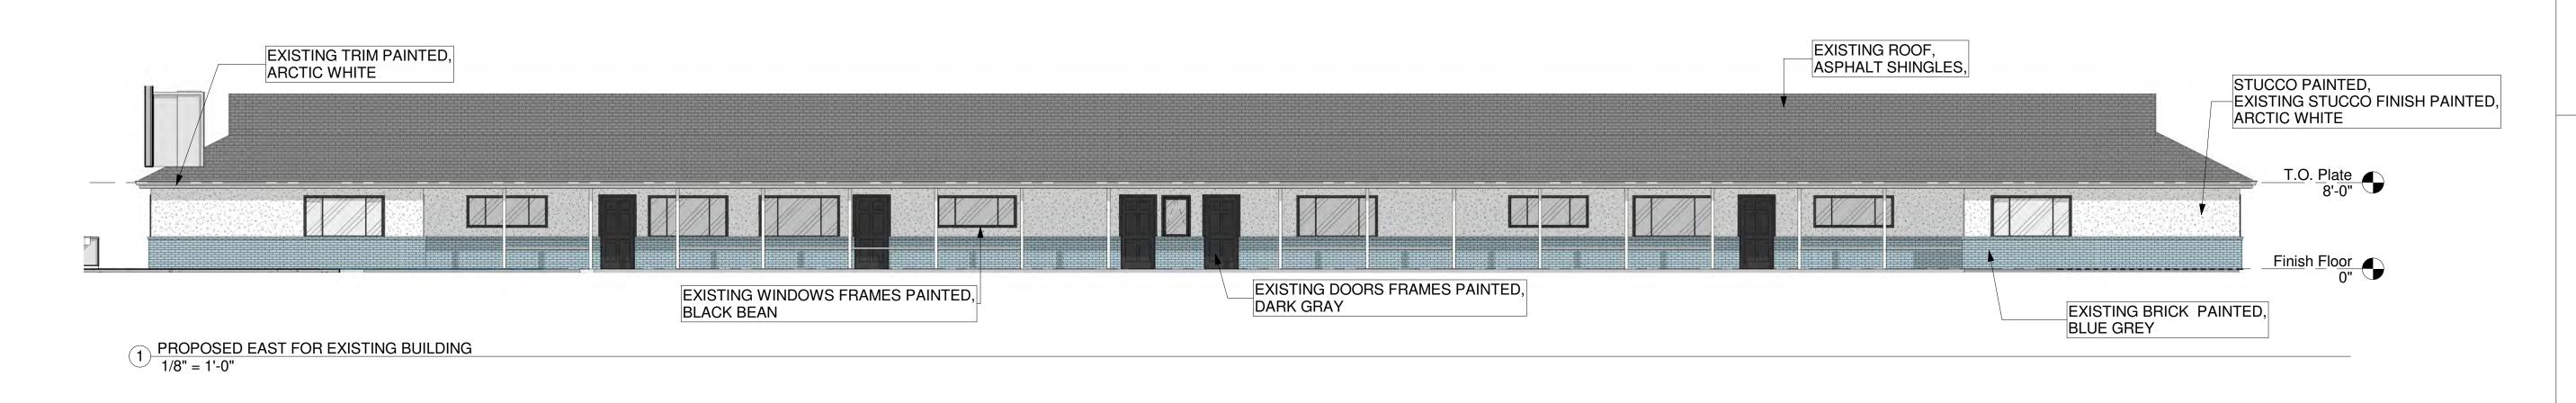

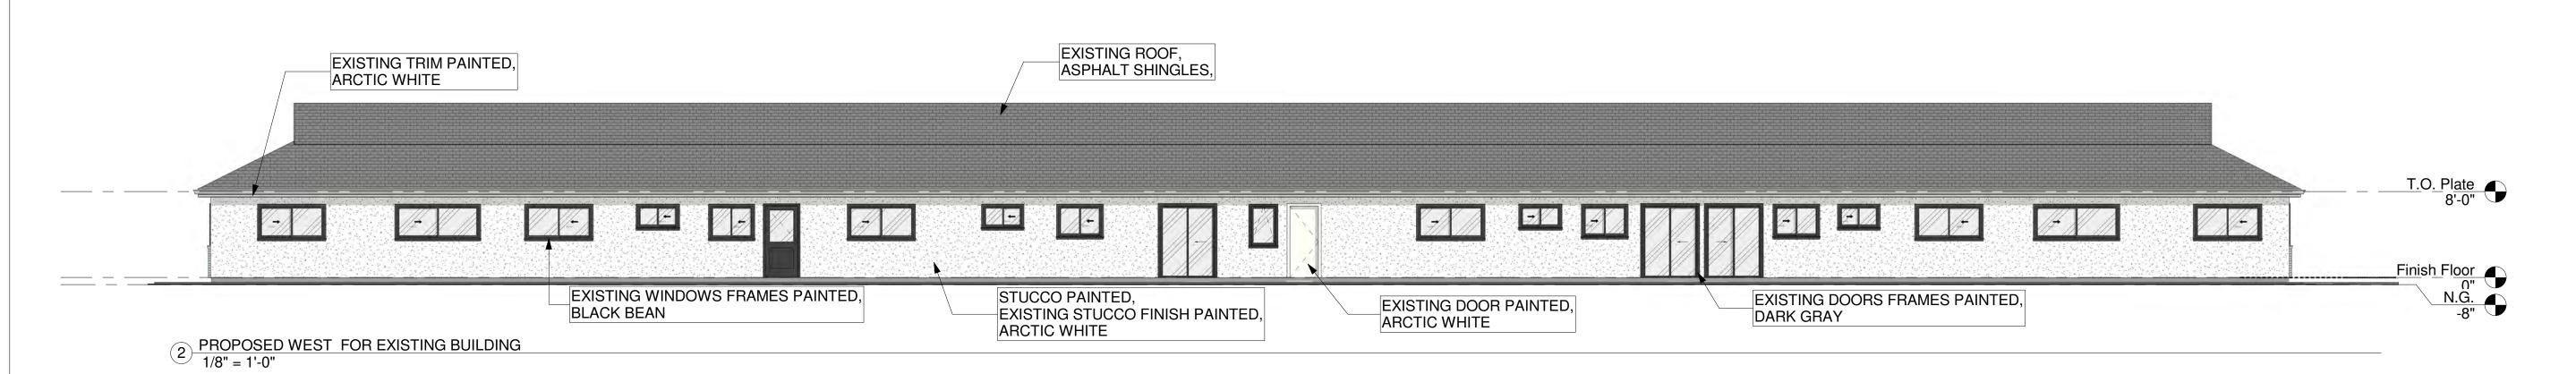



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HARBEN APARTMENTS SCHEMATIC DESIGN

A3.4


EXISTING BUILDING PROPOSED ELEVATION

EXTERIOR FINISH KEY ROOFING OPTION 1 METAL PANEL ROOFING 'CHARCOAL GRAY' HORIZONTAL SIDING - <u>HARDIE® PLANK LAP</u> <u>SIDING SMOOTH OR SIMILAR</u>, 'ARCTIC WHITE'



ROOFING OPTION 2 - CHOSEN

LAMINATE ARCHITECTURAL ROOFING SHINGLES - OWENS CORNING, 'OAKRIDGE ONYX BLACK'

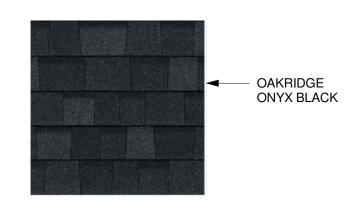




NOTES: SCHEMATIC DESIGNS, NOT FOR CONSTRUCTION.


ARCTIC WHITE

BLUE GREY


VERTICAL SIDING -<u>HARDIE® PANEL VERTICAL</u> <u>SIDING, SMOOTH,</u> 'ARCTIC WHITE'

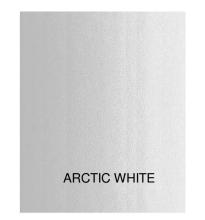

BOARD AND BATTEN STRIPS ON T1-11 SIDING - 'ARCTIC WHITE'

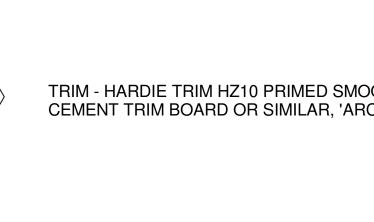

TRIM - HARDIE TRIM HZ10 PRIMED SMOOTH FIBER CEMENT TRIM BOARD OR SIMILAR, 'ARCTIC WHITE'

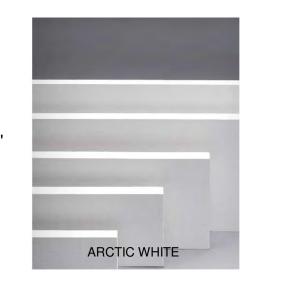

STUCCO - <u>LAHABRA</u> FINISH COAT STUCCO OR SIMILAR, 'BLUE GREY'



DOOR - 36 IN. X 79 IN. FIBERGLASS DOORS, COLOR 'DARK GRAY' $\langle \mathsf{H} \rangle$




WINDOWS - MILGARD ULTRA™ SERIES FIBERGLASS CASEMENT WINDOWS, COLOR: 'BLACK BEAN'



ARCTIC WHITE

RAILING - TREX SIGNATURE ALUMINUM $\langle \mathbf{K} \rangle$ RAILING LEVEL PRE-ASSEMBLED RAIL PANEL - COLOR 'CHARCOAL BLACK'

GARAGE DOORS - COPLAY FIBERGLASS INSULATED WHITE GARAGE DOOR WITH PLAIN WINDOWS 'WHITE'

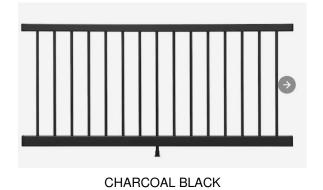


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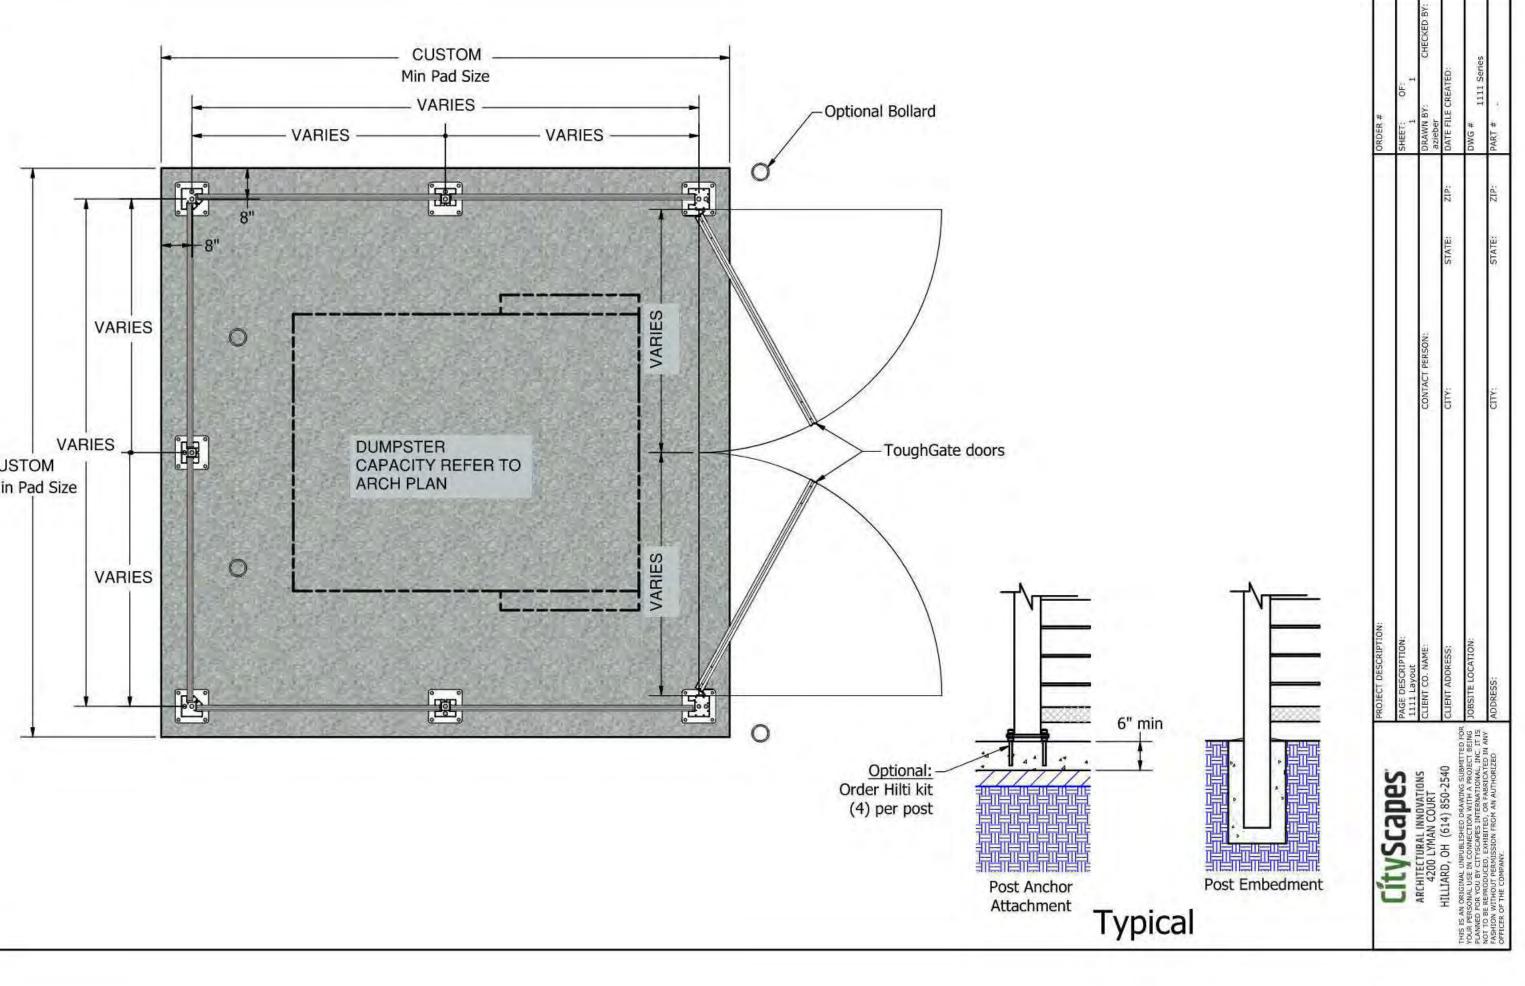
Sabu Shake Jr. sabu@fishhopper.com 226 Harben Cir Marina Ca 93933

HARBEN APARTMENTS SCHEMATIC DESIGN


A4.1

EXTERIOR FINISH



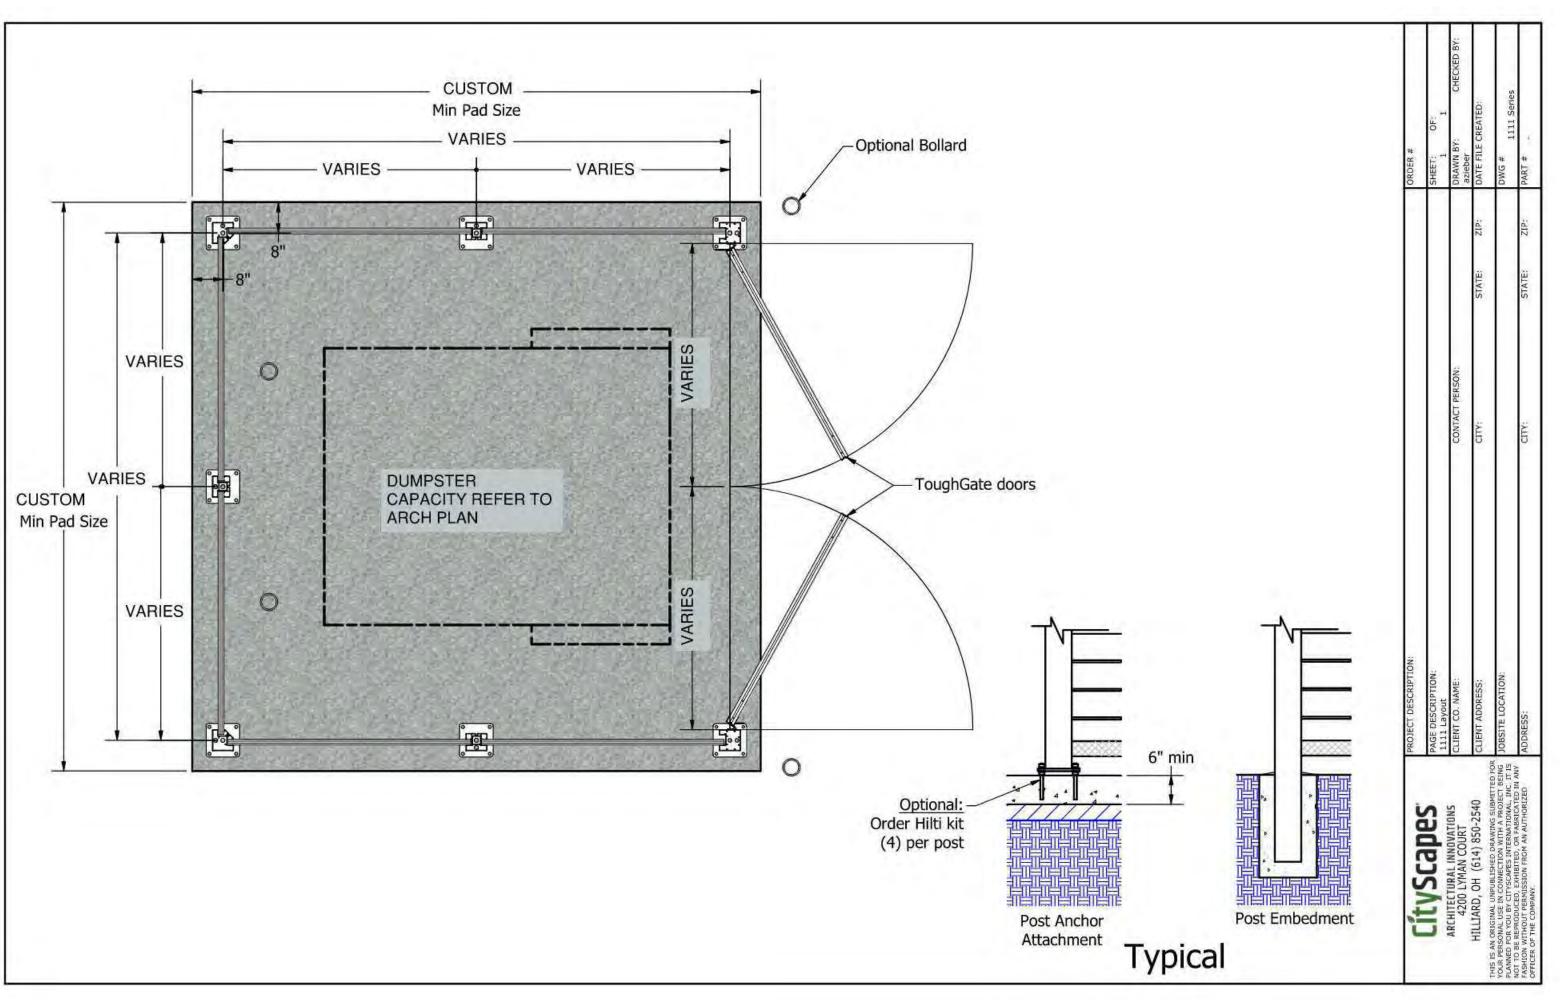



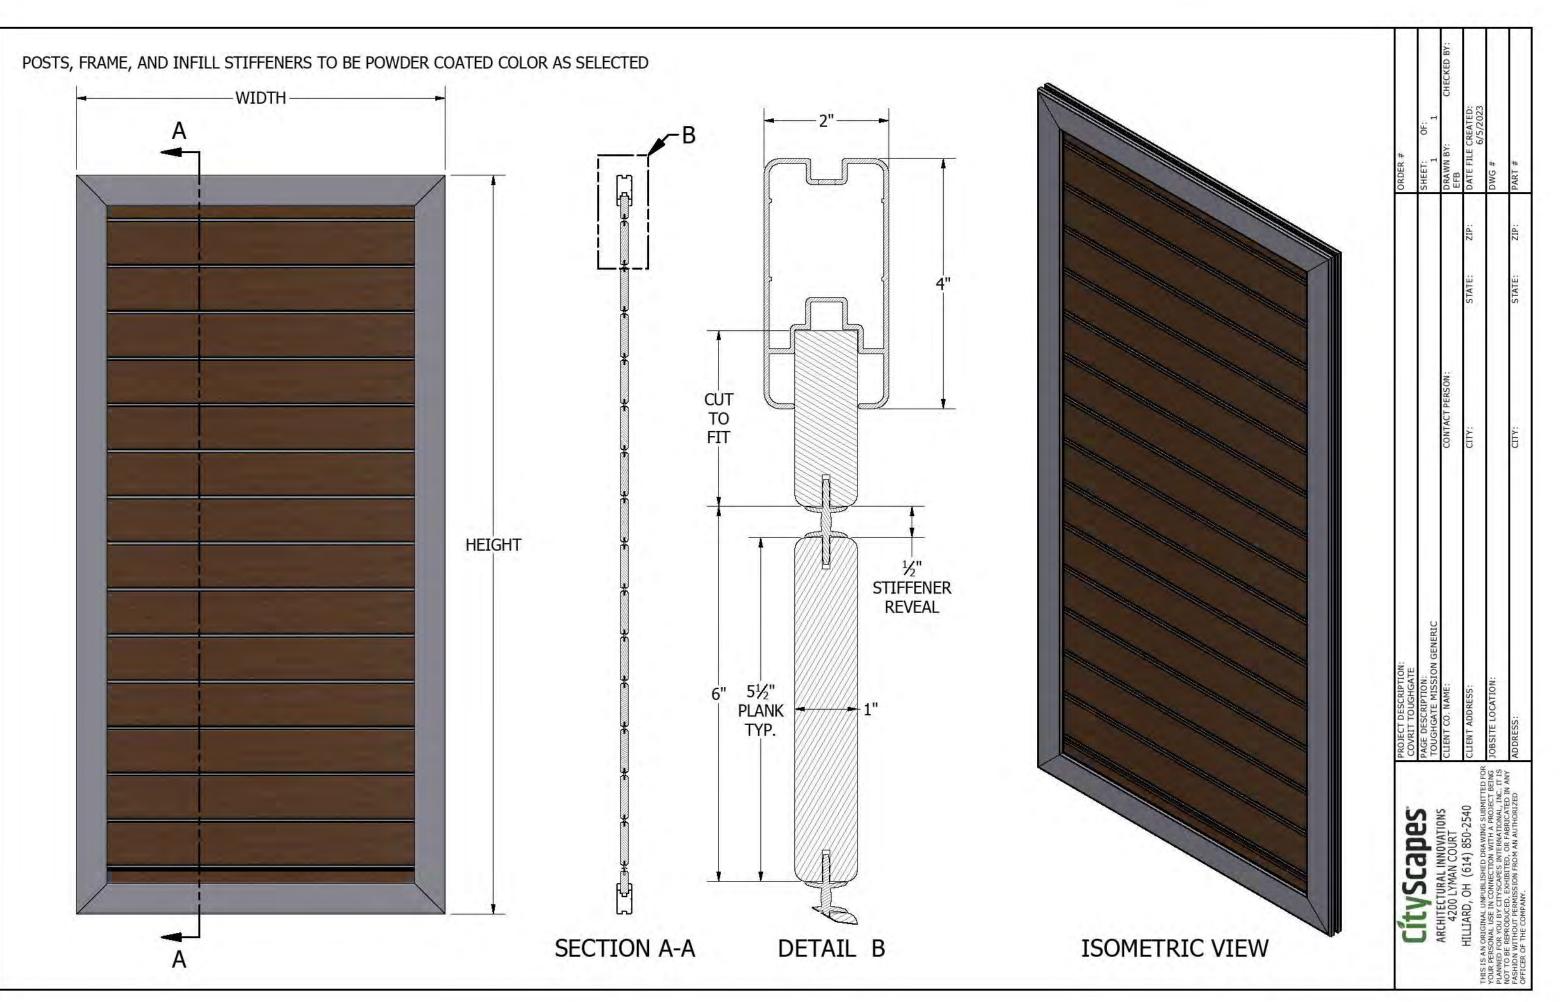


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HARBEN APARTMENTS SCHEMATIC DESIGN

A7.3

TRASH ENCLOSURE



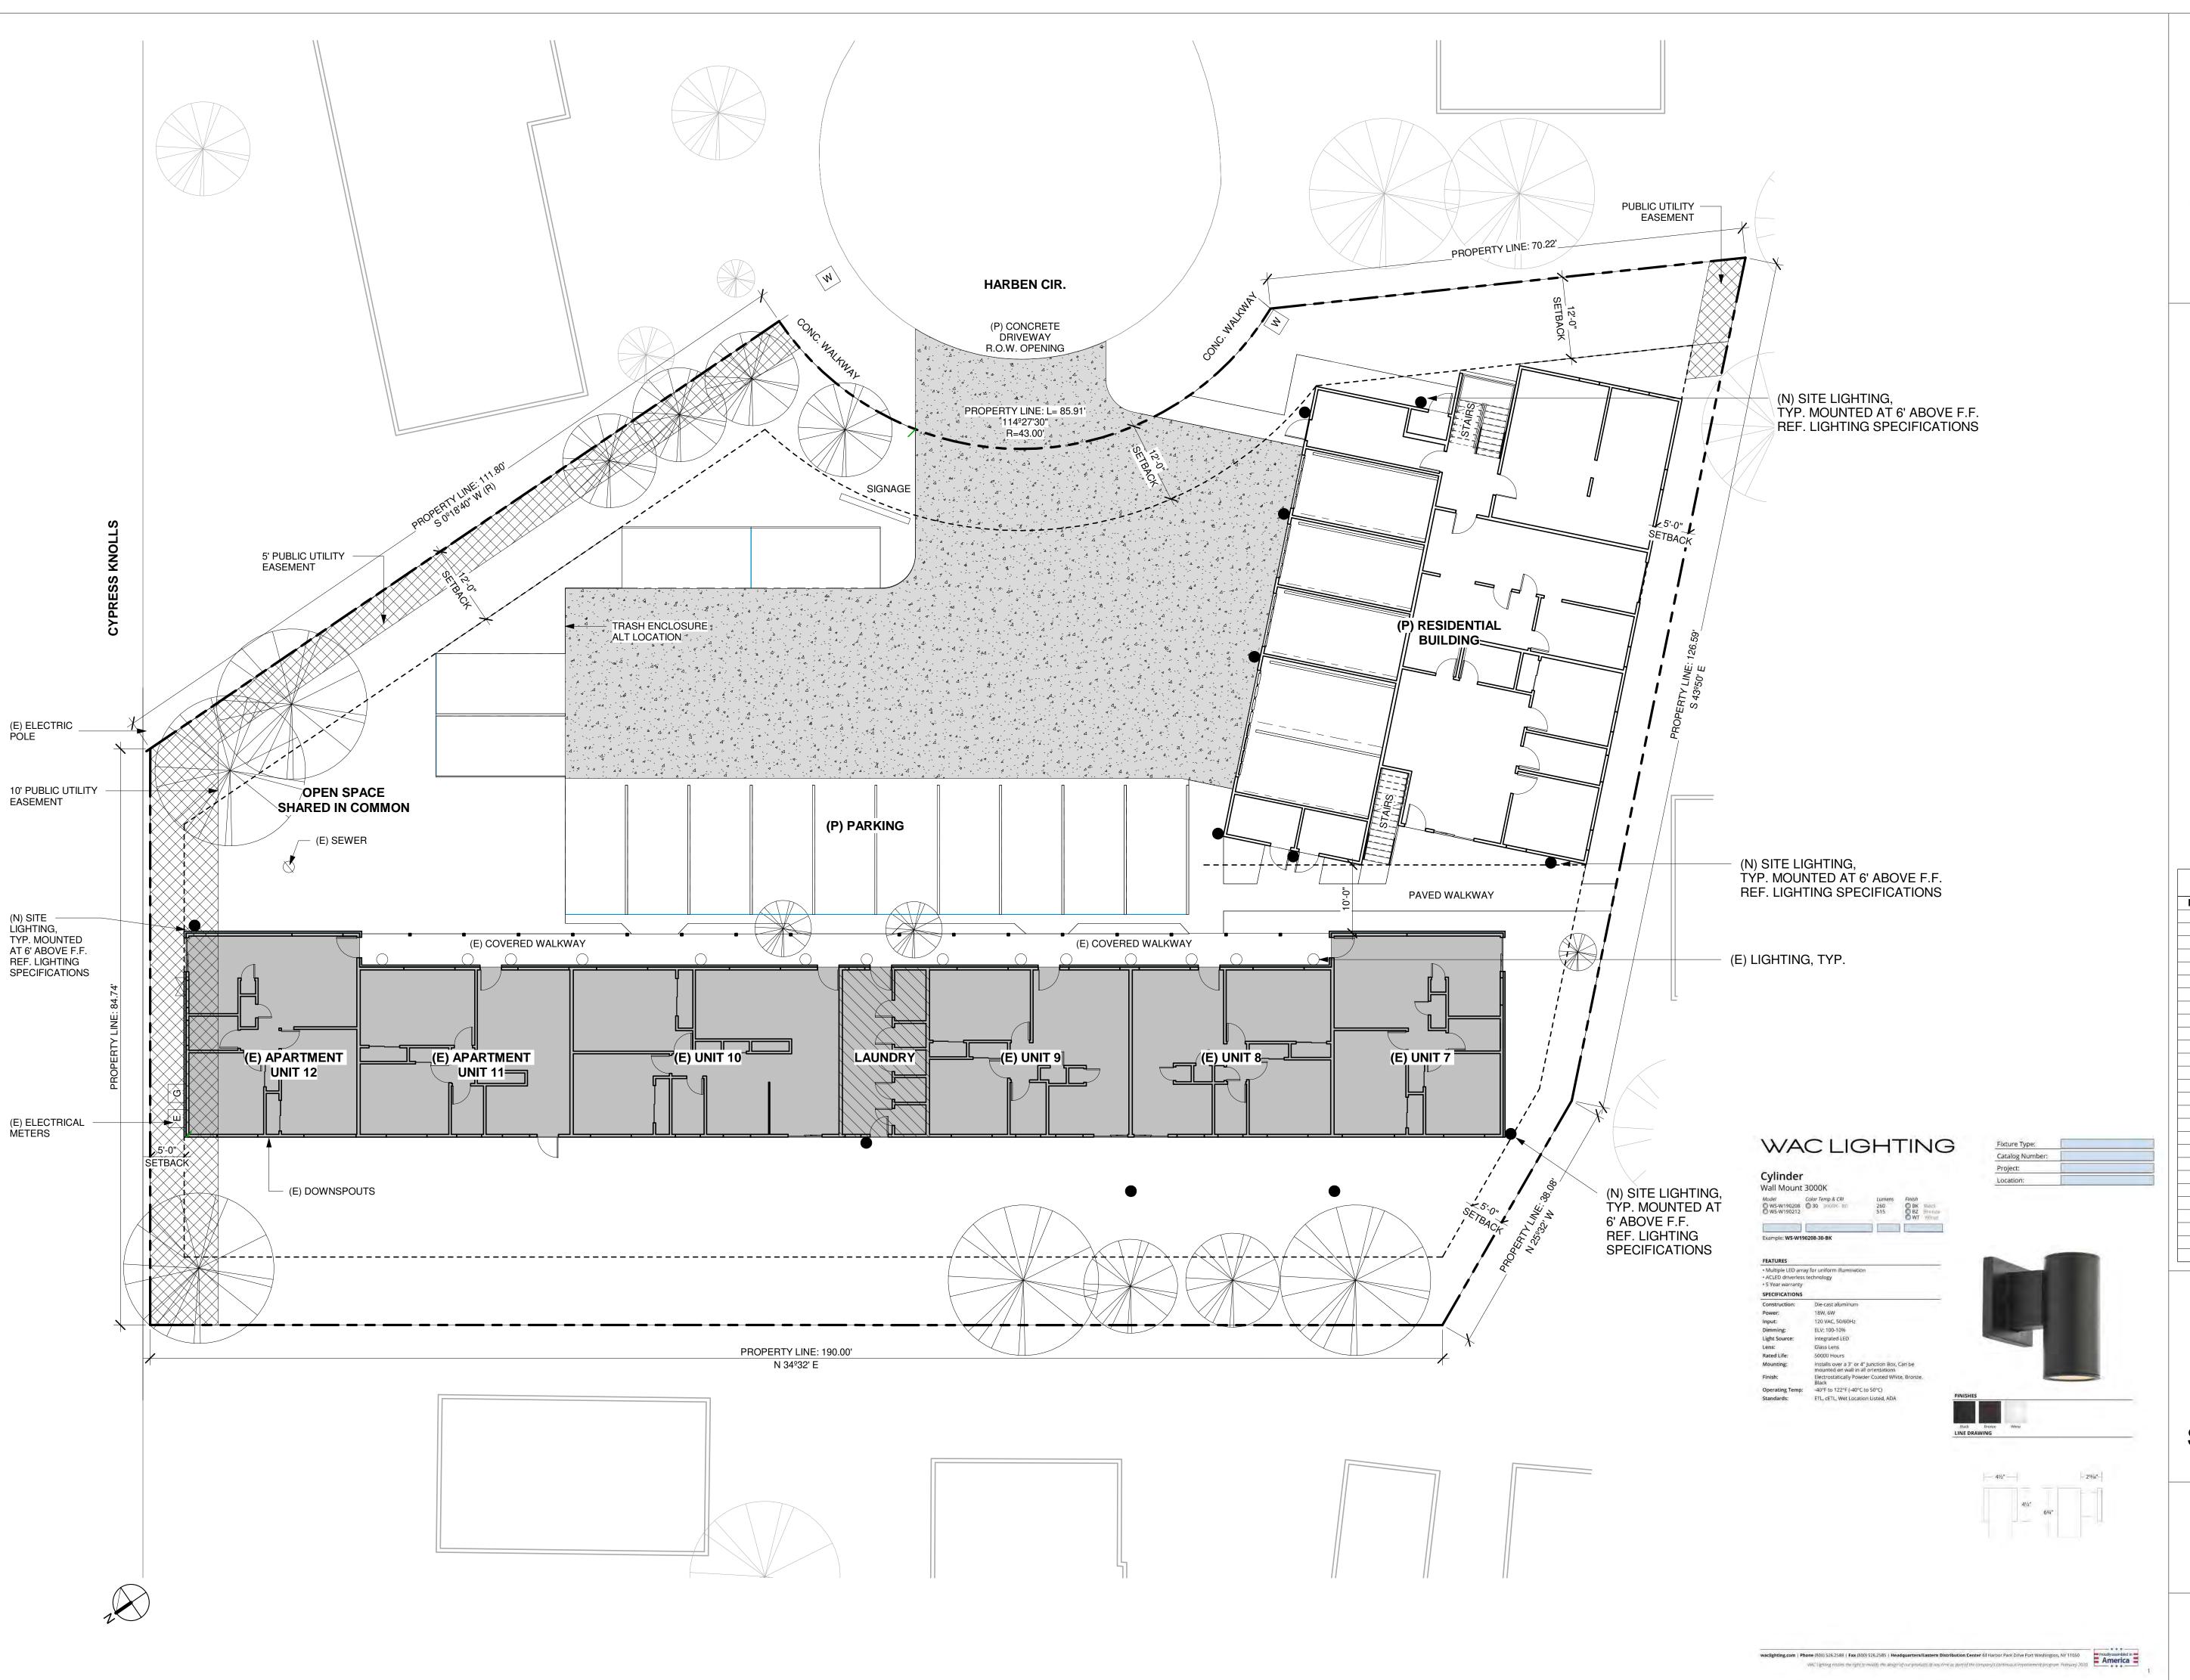

PER ODS 1.3.1(E):
PEDESTRIAN-ORIENTED LIGHTING
MUST BE PLACED AT MINIMUM
INTERVALS OF 40 FEET ALONG
PATHWAYS AND MUST BE NO
TALLER THAN 12 FEET
ALL OTHER LIGHTING MUST BE NO
TALLER THAN 16 FEET.
LIGHTING MUST BE DIRECTED,
ORIENTED, AND SHIELDED TO
PREVENT GLARE ONTO ADJACENT
PROPERTIES. MAXIMUM INTENSITY
IS 1,000 LUMENS.
MAXIMUM LIGHTING TEMPERATURE
IS 3,000 KELVIN

No. Description						
	· · · · · · · · · · · · · · · · · · ·	Date				

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226 Harben Cir Marina Ca 93933

HARBEN APARTMENTS SCHEMATIC DESIGN

E1.0

SITE LIGHTING PLAN

226 HARBEN CIRCLE

MARINA, CALIFORNIA APN 032031034000




GENERAL NOTES

- 1. CONTRACTOR SHALL VERIFY WITH OWNER'S REPRESENTATIVE THAT PLANS ARE CURRENT AND APPROVED. 2. WORK SHALL BE IN ACCORDANCE WITH THE REQUIREMENTS OF THE CITY OF
- MARINA / COUNTY OF MARINA. 3. THESE PLANS ARE BASED ON IMPROVEMENT PLANS BY (HOUSABLE) DATED
- 4. THE GEOTECHNICAL SOILS ENGINEERING REPORT BY (GEOTECH. SOILS ENG. CO. NAME) DATED (DATE) IS A PART OF THESE CONSTRUCTION DOCUMENTS. THE CONTRACTOR SHALL COMPLY WITH THE REPORT'S RECOMMENDATIONS AS THEY RELATE TO HIS WORK.
- 5. THE CONTRACTOR SHALL OBTAIN ALL NECESSARY AND/OR REQUIRED PERMITS AND PAY ALL RELATED FEES AND/OR TAXES REQUIRED TO INSTALL THE WORK ON THESE PLANS.
- 6. THE CONTRACTOR SHALL BE APPROPRIATELY LICENSED AS REQUIRED BY THE STATE IN WHICH THE WORK TAKES PLACE. 7. A SEPARATE PLUMBING PERMIT AND INSPECTION WILL BE REQUIRED FROM
- THE BUILDING INSPECTION DEPARTMENT FOR THE INSTALLATION OF IRRIGATION SYSTEMS SHOWN ON THIS DRAWING. 8. THE CONTRACTOR SHALL NOTIFY THE OWNER'S REPRESENTATIVE PRIOR TO BEGINNING THE WORK AND SHALL BE RESPONSIBLE FOR COORDINATING WITH THE OWNER, LANDSCAPE ARCHITECT, GOVERNING AGENCIES AND OTHER
- 9. CONTRACTOR SHALL NOTIFY LANDSCAPE ARCHITECT IMMEDIATELY OF ANY ERRORS, OMISSIONS OR DISCREPANCIES IN EXISTING CONDITIONS OR
- WITHIN THE PLANS PRIOR TO BEGINNING THE WORK. 10. UNIT PRICES FOR ALL IMPROVEMENTS SHALL BE ESTABLISHED AS A PART OF THE CONTRACT WITH THE PROJECT OWNER AND PRIOR TO BEGINNING WORK, TO ACCOMMODATE ADDITIONS AND/OR DELETIONS OF MATERIAL AND/OR
- 11. DETERMINATION OF "EQUAL" SUBSTITUTIONS SHALL BE MADE ONLY BY THE
- LANDSCAPE ARCHITECT. 12. LANDSCAPE ARCHITECT SHALL BE NOTIFIED NO LESS THAN 48 HOURS IN
- ADVANCE OF ANY SITE OBSERVATIONS OR MEETINGS.
- 13. SITE OBSERVATIONS AND MEETINGS SHALL INCLUDE:
- A. PRE-CONSTRUCTION CONFERENCE
- B. SELECTION AND TAGGING OF SPECIMEN TREES AT NURSERIES C. LANDSCAPE GRADING PRIOR TO PLANTING
- D. LAYOUT AND INSTALLATION OF HARDSCAPE AND LANDSCAPE STRUCTURES IN RELATION TO DESIGN INTENT
- E. PLANT MATERIAL QUALITY AND INSTALLATION AT THE PROJECT SITE
- F. OBSERVATION TO ESTABLISH 90-DAY MAINTENANCE PERIOD
- (PRE-MAINTENANCE) G. FINAL OBSERVATION AT THE END OF THE 90-DAY MAINTENANCE PERIOD

NOTE: "LANDSCAPE" SHALL REFER TO ALL IMPROVEMENTS WITHIN THIS SET OF DOCUMENTS THAT HAVE BEEN DESIGNED BY THIS OFFICE.

VICINITY MAP

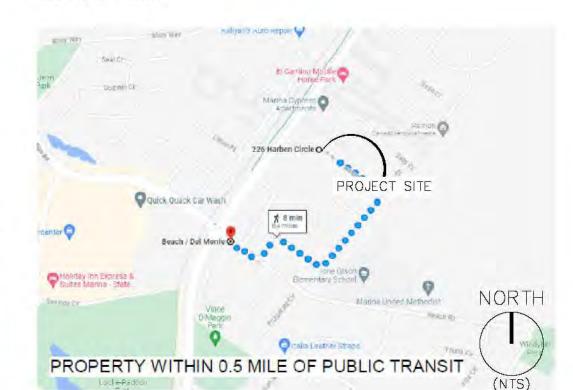

PROJECT TEAM

CLIENT MARINA HARBEN APTS LLC 700 CANNERY ROW MONTEREY CA 93490 CONTACT: SABU SHAKE JR SABU@FISHHOPPER.COM

LANDSCAPE ARCHITECT BLOCS DESIGN GROUP, PC 3800 MAYBELLE AVE, UNIT 6 OAKLAND CA 94619 CONTACT: BLAKE TOMILLOSO-RHINEHART

BLAKE@BLOCSDESIGNGROUP.COM

DESIGNER HOUSEABLE INC. 2269 CHESTNUT ST #122 SAN FRANCISCO, CA 94123 CONTACT: LJ CHAO

LJ@HOUSABLE.COM

SHEET INDEX

Sheet Number Sheet Title L0.00 COVER SHEET L1.01 LANDSCAPE CONSTRUCTION PLAN L1.10 CONSTRUCTION DETAILS L1.20 CONSTRUCTION SPECIFICATIONS L1.21 CONSTRUCTION SPECIFICATIONS L3.01 IRRIGATION PLAN L2.10 IRRIGATION DETAILS L2.20 IRRIGATION SPECIFICATIONS L2.21 IRRIGATION SPECIFICATIONS PLANTING PLAN L3.10 PLANTING DETAILS L3.20 PLANTING SPECIFICATIONS L3.21 PLANTING SPECIFICATIONS


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REVISIONS

SHEET TITLE **COVER SHEET**



LANDCADE CALCULATIONS

OPEN SPACE AMENITY PROVIDED: 1 AMENITY - SHADED PICNIC SHELTER/TABLE

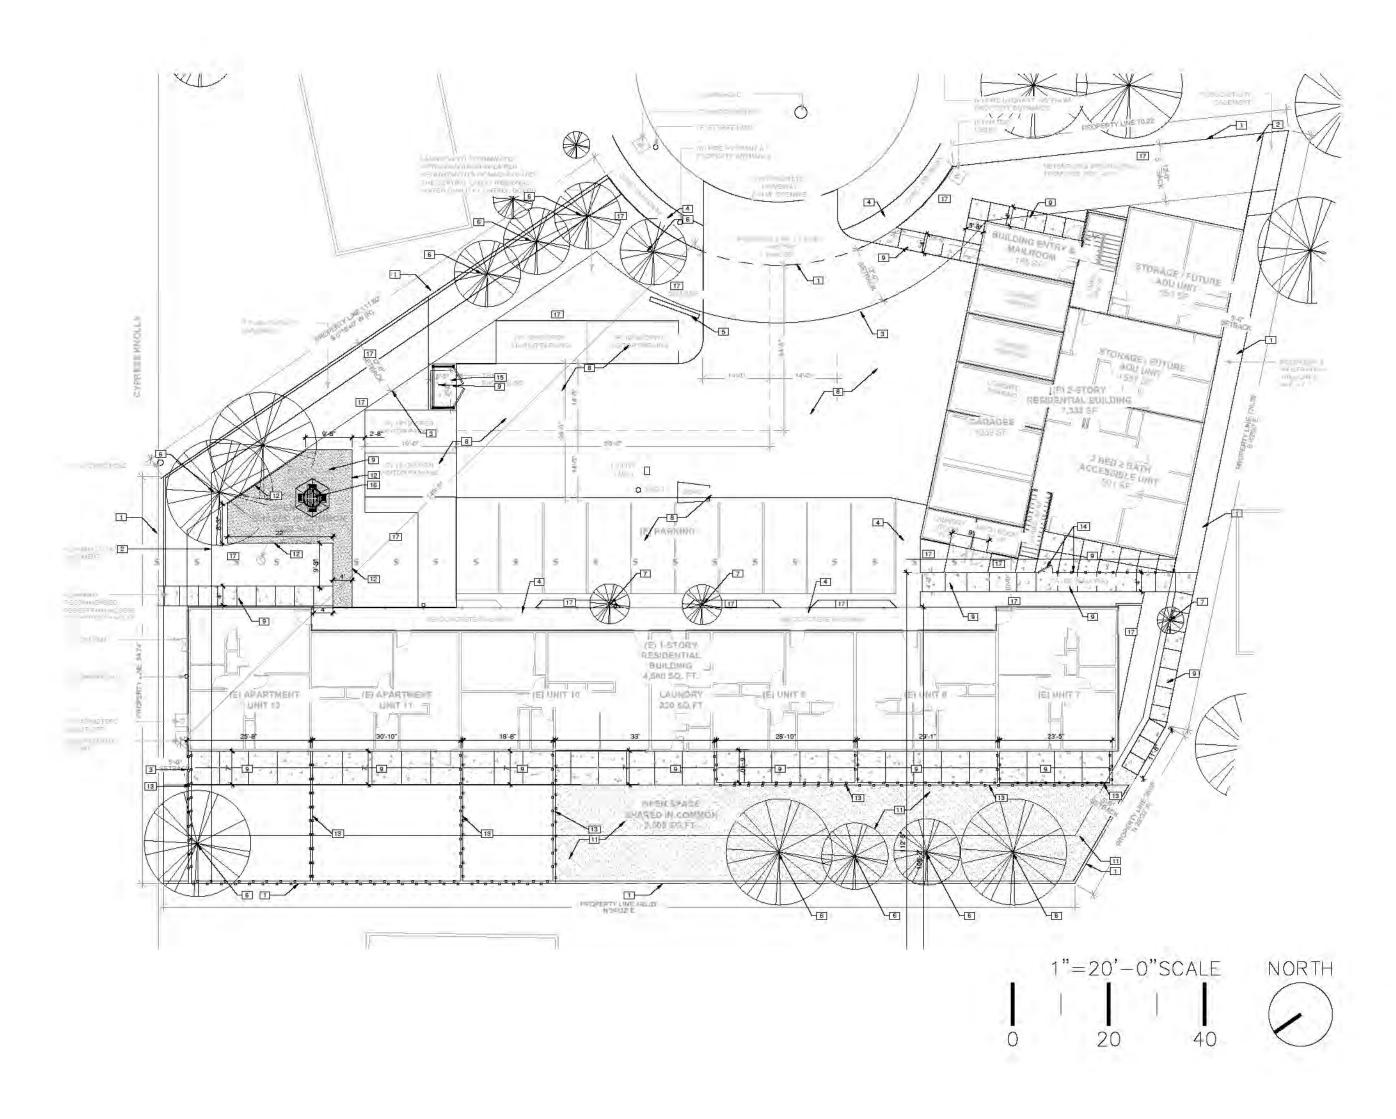LOT AREA:	28,289 SF	PLANTING CALCULATIONS	
TOTAL LANDSCAPE AREA:	9,405 SF (33% OF LOT)	REQUIRED DROUGHT TOLERANT PLANTING:	6,113 SF (65% OF LANDSCAPE AREA)
TOTAL PLANTING AREA:	6,660 SF	PROVIDED DROUGHT TOLERANT PLANTING:	6,660 SF (70.8%)
REQUIRED OPEN SPACES:	4,800 SF	MAXIMUM TURF ALLOWED:	2,351 SF (25% OF LANDSCAPE AREA)
PROVIDED OPEN SPACES:	4,822 SF	TURF PROPOSED:	0 SF (0%)
PROVIDED PRIVATE OPEN SPACE:	3,017 SF		
		TOTAL TREES PROPOSED:	1 TREE
OPEN SPACE PLANTING REQUIRED:	965 SF (20%)	24" BOX TREES REQUIRED:	1 TREE (50%)
OPEN SPACE PLANTING PROVIDED:	2,365 SF (49%)	24" BOX TREES PROVIDED:	1 TREE
OPEN SPACE TREES REQUIRED:	8 TREES (1 PER 600SF)	SHRUB SIZING:	5 GALLON MINIMUM
OPEN SPACES TREES PROVIDED:	7 EXISTING TREES, 1 PROPOSED		
		EXISTING TREES	
SEATING PROVIDED:	1 TABLE PROVIDED	EXISTING TREES:	15 TREES
OPEN SPACES SHADING PROVIDED:	50% PROVIDED BY PROPOSED TREES, EXISTING	TREES TO REMAIN:	11 TREES
	TREES AND UMBRELLA/SHELTER	TREES TO BE REMOVED	4 TREES
OPEN SPACE AMENITIES REQUIRED:	1 AMENITY (12 UNITS = 1 AMENITY)		

TO A TENTRAL OF PLOT HELL TO 7/10/24 FIRE MARKET AND A DESCRIPTION OF THE MARKET PROPERTY AND A DESCRIPTION OF THE PROPERTY AND A DESCRIPTIO

REFERENCE NOTES SCHEDULE

THE HOME DEPOT, OR APPROVED EQUAL

PLANTING AREA - REFER TO PLANTING PLANS

			G	SENERAL NOTES
CODE	DESCRIPTION	DETAIL	1.	CONTRACTOR SHALL VERIFY WITH OWNER'S REPRESENTATIVE THAT PLANS
1	PROPERTY LINE		2	ARE CURRENT AND APPROVED. WORK SHALL BE IN ACCORDANCE WITH THE REQUIREMENTS OF THE CITY OF
2	PUBLIC UTILITY EASEMENT (P.U.E.)			MARINA / COUNTY OF MARINA.
3	SETBACK		3.	THESE PLANS ARE BASED ON IMPROVEMENT PLANS BY (HOUSABLE) DATED (DATE).
-			4.	THE GEOTECHNICAL SOILS ENGINEERING REPORT BY (GEOTECH. SOILS ENG CO. NAME) DATED (DATE) IS A PART OF THESE CONSTRUCTION DOCUMENTS
4	EX. CONCRETE WALKWAY TO REMAIN			THE CONTRACTOR SHALL COMPLY WITH THE REPORT'S RECOMMENDATIONS
5	EX SIGNAGE		-	AS THEY RELATE TO HIS WORK.
6	EX. TREE TO REMAIN, PROTECT IN PLACE		5.	THE CONTRACTOR SHALL OBTAIN ALL NECESSARY AND/OR REQUIRED PERMITS AND PAY ALL RELATED FEES AND/OR TAXES REQUIRED TO INSTALL THE WORK ON THESE PLANS.
7	EX. TREE OR SHURB TO BE REMOVED		6.	THE CONTRACTOR SHALL BE APPROPRIATELY LICENSED AS REQUIRED BY TI
8	PARKING AREA BY OTHERS		7.	STATE IN WHICH THE WORK TAKES PLACE. A SEPARATE PLUMBING PERMIT AND INSPECTION WILL BE REQUIRED FROM
9	CONCRETE SIDEWALK - NATURAL GREY CONCRETE, BROOM FINISH			THE BUILDING INSPECTION DEPARTMENT FOR THE INSTALLATION OF IRRIGATION SYSTEMS SHOWN ON THIS DRAWING.
	SCORE PER PLAN. REINFORCEMENT, DEPTH, AND BASE MATERIAL PER STRUCTURAL ENG. OR GEOTECHNICAL REPORT.		8.	THE CONTRACTOR SHALL NOTIFY THE OWNER'S REPRESENTATIVE PRIOR TO BEGINNING THE WORK AND SHALL BE RESPONSIBLE FOR COORDINATING WI
[aa]				THE OWNER, LANDSCAPE ARCHITECT, GOVERNING AGENCIES AND OTHER
11	WALKABLE MULCH - 3" DEPTH FOREST MULCH AVAILABLE FROM KEITH DAY LANDSCAPE SUPPLY OR APPROVED EQUAL			TRADES.
1			9.	CONTRACTOR SHALL NOTIFY LANDSCAPE ARCHITECT IMMEDIATELY OF ANY ERRORS, OMISSIONS OR DISCREPANCIES IN EXISTING CONDITIONS OR
12	COMPOSITE EDGING - 1" X 4" COMPOSITE EDGING COLOR BROWN.			WITHIN THE PLANS PRIOR TO BEGINNING THE WORK.
	STAKE WITH COMPOSITE LANDSCAPE STAKE PER MANUFACTURE RECOMMENDATIONS		10.	UNIT PRICES FOR ALL IMPROVEMENTS SHALL BE ESTABLISHED AS A PART OF
	REGOMMENDATIONS			THE CONTRACT WITH THE PROJECT OWNER AND PRIOR TO BEGINNING WOR
13	5' PATIO FENCE - REFER TO DETAIL ON SHEET L1.20			TO ACCOMMODATE ADDITIONS AND/OR DELETIONS OF MATERIAL AND/OR LABOR.
14	42" PATIO FENCE - REFER TO DETAIL ON SHEET L1.20		11.	DETERMINATION OF "EQUAL" SUBSTITUTIONS SHALL BE MADE ONLY BY THE LANDSCAPE ARCHITECT.
15	TRASH ENCLOSURE - REFER TO DETAIL ON SHEET L1.20		12.	LANDSCAPE ARCHITECT SHALL BE NOTIFIED NO LESS THAN 48 HOURS IN
[40]	DATIO TARLE WILLIAMSELLA TARLE LONDAMA COLMATURAL ROLLING		12	ADVANCE OF ANY SITE OBSERVATIONS OR MEETINGS. SITE OBSERVATIONS AND MEETINGS SHALL INCLUDE:
16	PATIO TABLE W/ UMBRELLA - TABLE: LONDAMA 63" NATURAL ROUNI WOOD OUTDOOR TABLE, UMBRELLA: DUBBIN 9' STEEL MARKET)	13.	A. PRE-CONSTRUCTION CONFERENCE
	TITLE PATIO UMBRELLA, COLOR BEIGE, W/ BASE AVAILABLE FROM			B. SELECTION AND TAGGING OF SPECIMEN TREES AT NURSERIES
	THE HOME DEPOT OF APPROVED FOLIAL			C LANDSCARE CRADING PRIOR TO BLANTING

GENERAL NOTES

- ALL VERIFY WITH OWNER'S REPRESENTATIVE THAT PLANS D APPROVED.
- ACCORDANCE WITH THE REQUIREMENTS OF THE CITY OF
- BASED ON IMPROVEMENT PLANS BY (HOUSABLE) DATED
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 R SHALL OBTAIN ALL NECESSARY AND/OR REQUIRED
 Y ALL RELATED FEES AND/OR TAXES REQUIRED TO INSTALL
- ESE PLANS.
- THE SEPLANS.

 OR SHALL BE APPROPRIATELY LICENSED AS REQUIRED BY THE THE WORK TAKES PLACE.

 IMBING PERMIT AND INSPECTION WILL BE REQUIRED FROM SPECTION DEPARTMENT FOR THE INSTALLATION OF TEMS SHOWN ON THIS DRAWING.
- SHALL NOTIFY THE OWNER'S REPRESENTATIVE PRIOR TO ORK AND SHALL BE RESPONSIBLE FOR COORDINATING WITH SCAPE ARCHITECT, GOVERNING AGENCIES AND OTHER
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- PRIOR TO BEGINNING THE WORK. ALL IMPROVEMENTS SHALL BE ESTABLISHED AS A PART OF /ITH THE PROJECT OWNER AND PRIOR TO BEGINNING WORK,
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NOTE: "LANDSCAPE" SHALL REFER TO ALL IMPROVEMENTS WITHIN THIS SET OF DOCUMENTS THAT HAVE BEEN DESIGNED BY THIS OFFICE.



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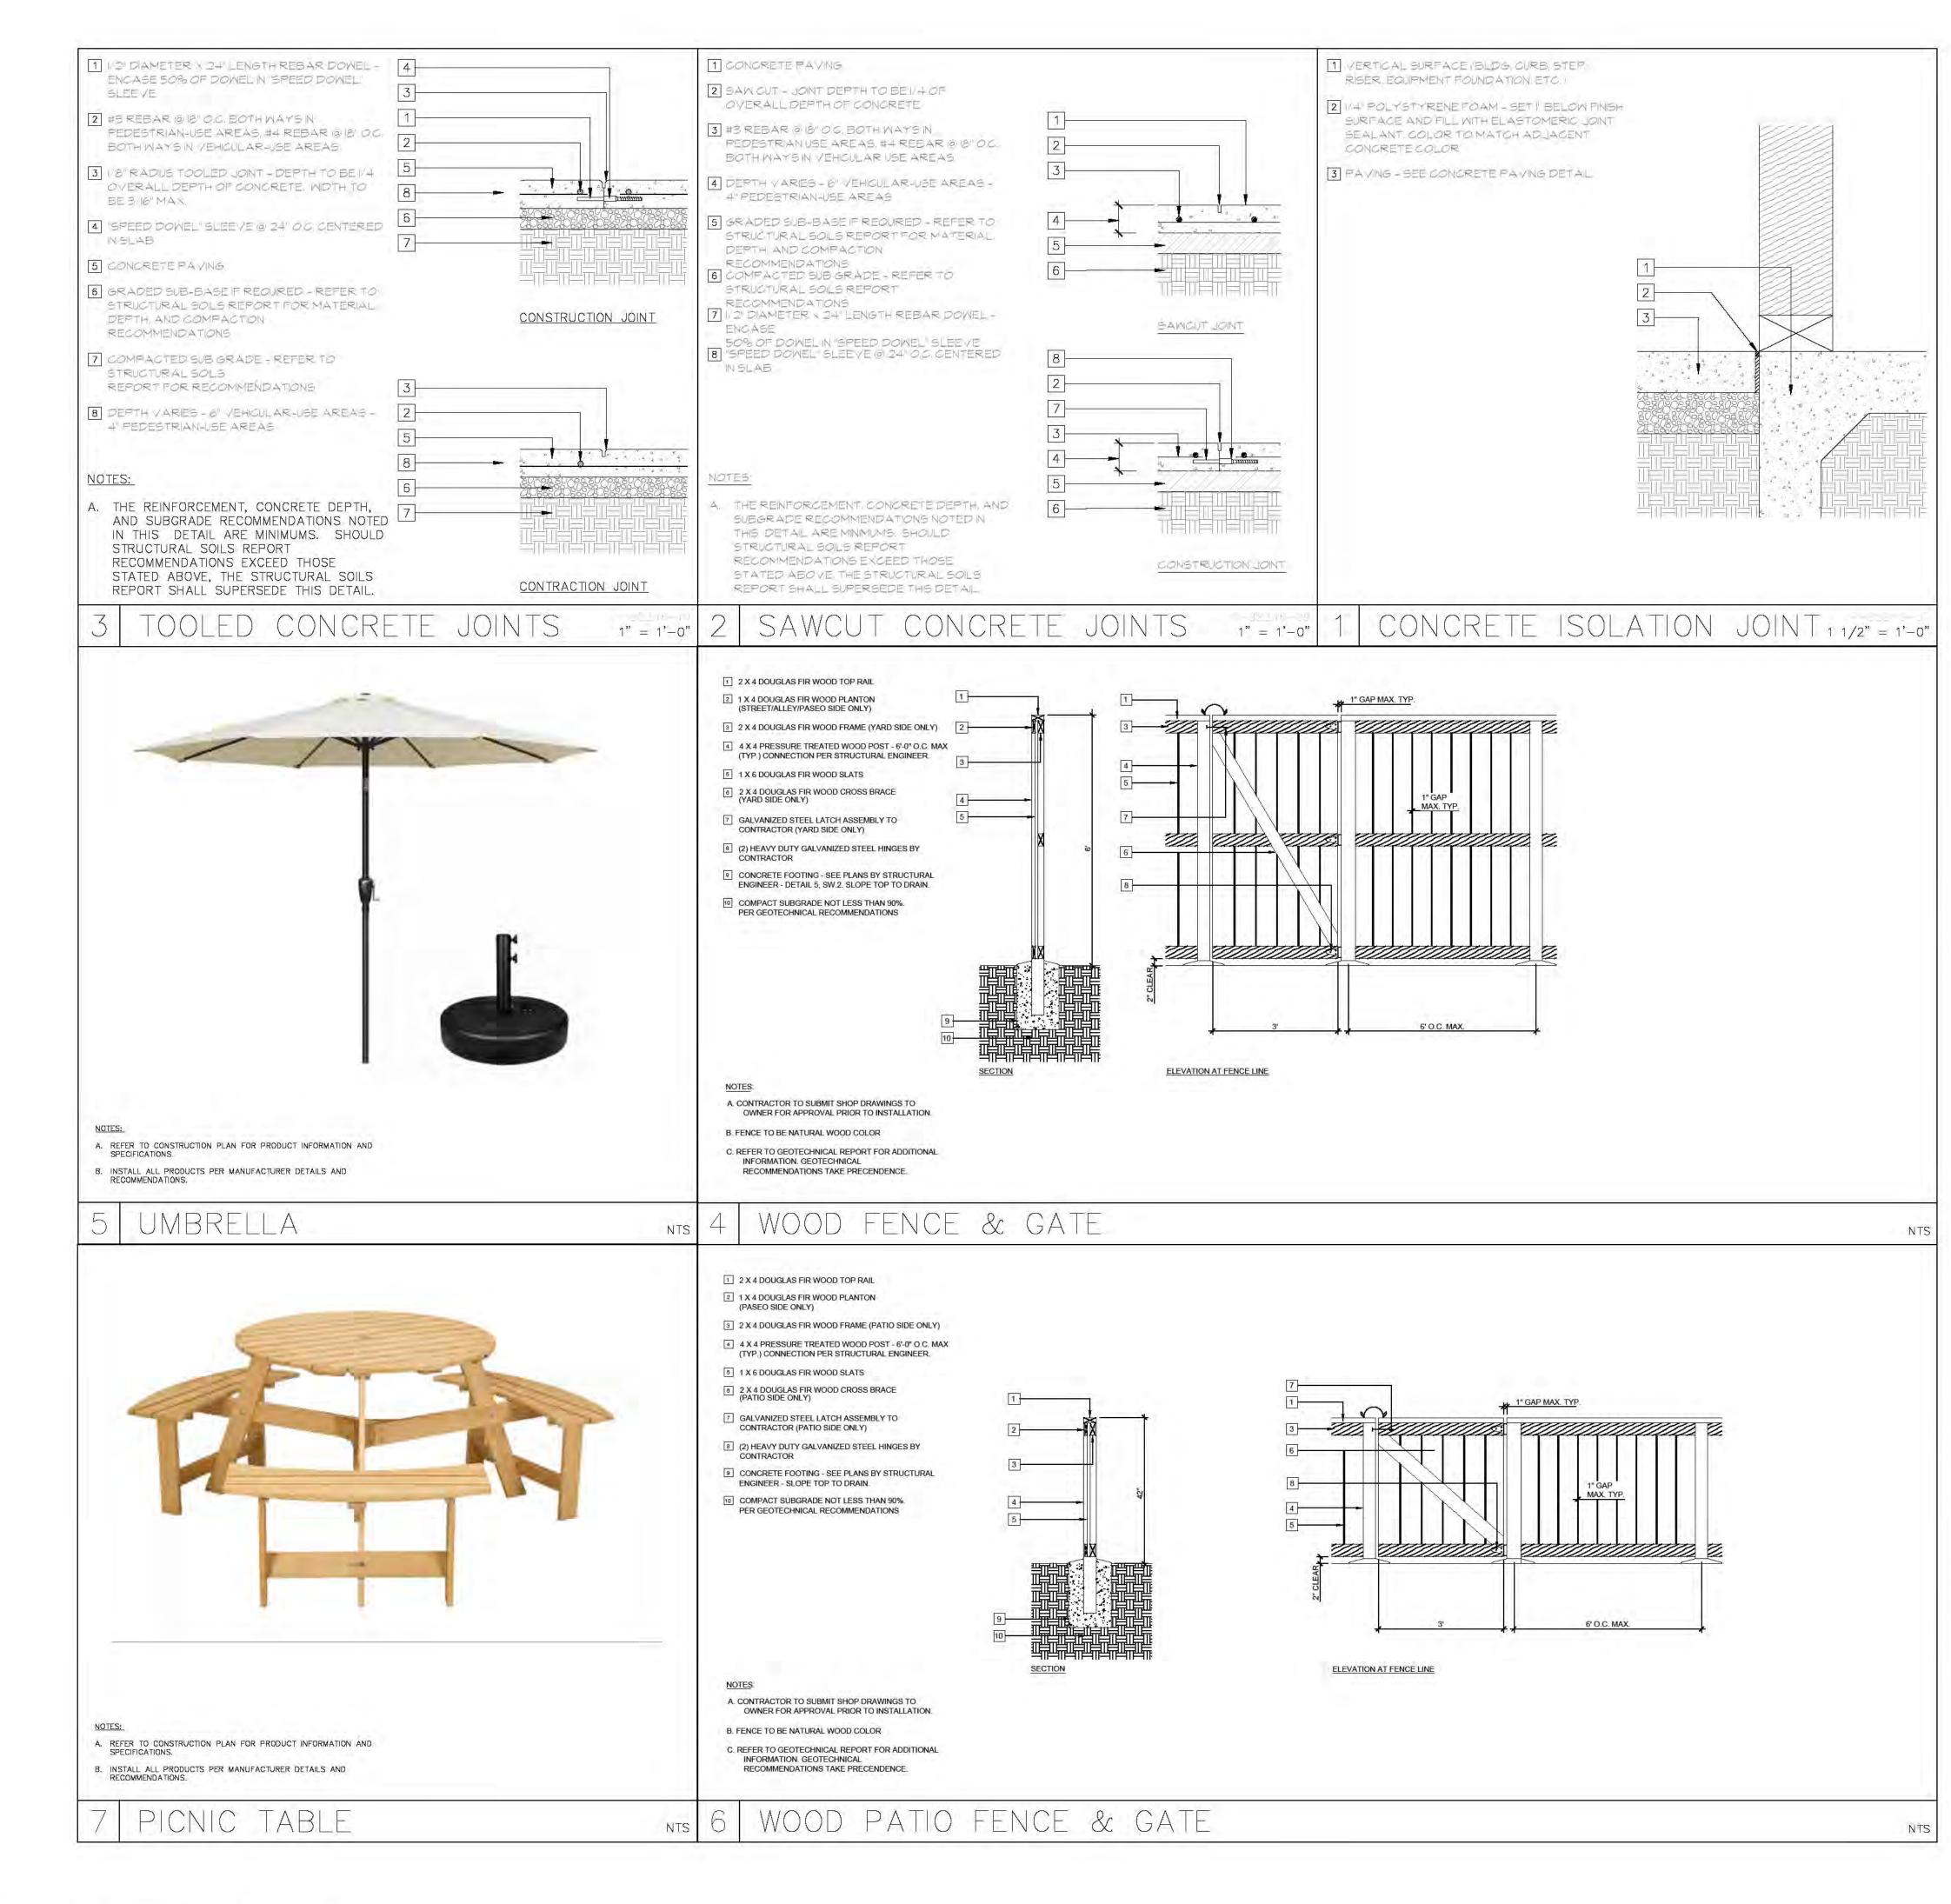


HARBEN

REVISIONS

SHEET TITLE LANDSCAPE CONSTRUCTION PLAN






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HARBEN .C

REVISIONS

SHEET TITLE CONSTRUCTION DETAILS



MWELO STATEMENT

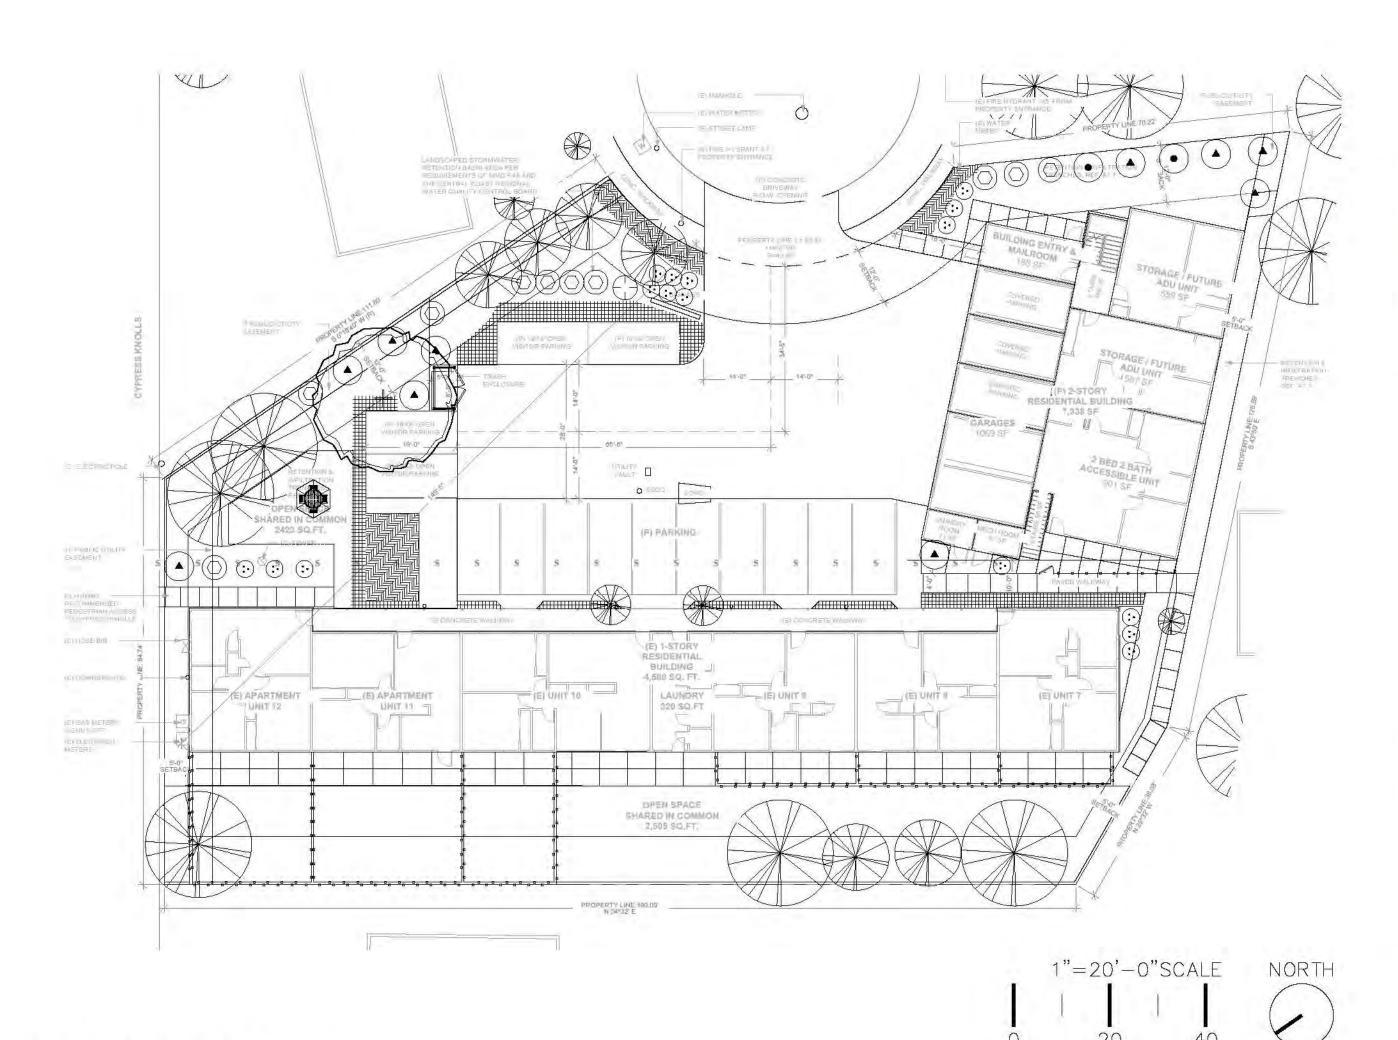I HAVE COMPLIED WITH THE CRITERIA OF THE WATER EFFICIENT LANDSCAPE ORDINANCE AND APPLIED SUCH CRITERIA FOR THE EFFICIENT USE OF WATER IN THE LANDSCAPE DESIGN PLAN.



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MULCHES

AFTER ALL PLANTING IS COMPLETE, CONTRACTOR SHALL INSTALL 3" THICK LAYER OF 1-1/2" SHREDDED WOOD MULCH, RECYCLED, NATURAL (UNDYED), OVER LANDSCAPE FABRIC IN ALL PLANTING AREAS (EXCEPT FOR TURF AND SEEDED AREAS). CONTRACTOR SHALL SUBMIT SAMPLES OF ALL MULCHES TO LANDSCAPE ARCHITECT AND OWNER FOR APPROVAL PRIOR TO CONSTRUCTION. ABSOLUTELY NO EXPOSED GROUND SHALL BE LEFT SHOWING ANYWHERE ON THE PROJECT AFTER MULCH HAS BEEN INSTALLED (SUBJECT TO THE CONDITIONS AND REQUIREMENTS OF THE "GENERAL GRADING AND PLANTING NOTES" AND SPECIFICATIONS).

THE FOLLOWING TYPES OF MULCH SHALL NOT BE ALLOWED INCLUDING: BARK MULCH, GORILLA HAIR, SHREDDED CEDAR, OR VIRGIN MATERIALS.

ORGANIC MULCH MATERIALS MADE FROM RECYCLED OR POST-CONSUMER SHALL TAKE PRECEDENCE OVER INORGANIC MATERIALS OR VIRGIN FOREST PRODUCTS UNLESS THE RECYCLED POST-CONSUMER ORGANIC PRODUCTS ARE NOT LOCALLY AVAILABLE. ORGANIC MULCHES ARE NOT REQUIRED WHERE PROHIBITED BY LOCAL FUEL MODIFICATION PLAN GUIDELINES OR OTHER APPLICABLE LOCAL ORDINANCES.

A MINIMUM THREE-INCH LAYER OF MULCH SHALL BE APPLIED ON ALL EXPOSED SOIL SURFACES OF PLANTING AREAS EXCEPT IN TURF AREAS, CREEPING OR ROOTING GROUNDCOVERS, OR DIRECT SEEDING APPLICATIONS WHERE MULCH IS CONTRAINDICATED.

ROOT BARRIERS

THE CONTRACTOR SHALL INSTALL ROOT BARRIERS NEAR ALL NEWLY-PLANTED TREES THAT ARE LOCATED WITHIN FIVE (5) FEET OF PAVING OR CURBS. ROOT BARRIERS SHALL BE "CENTURY" OR "DEEP-ROOT" 24" DEEP PANELS (OR EQUAL). BARRIERS SHALL BE LOCATED IMMEDIATELY ADJACENT TO HARDSCAPE. INSTALL PANELS PER MANUFACTURER'S RECOMMENDATIONS. UNDER NO CIRCUMSTANCES SHALL THE CONTRACTOR USE ROOT BARRIERS OF A TYPE THAT COMPLETELY ENCIRCLE THE ROOTBALL.

COMPOST

THE CONTRACTOR SHALL INSTALL COMPOST APPLICATION TO ACHIEVE A MINIMUM 6% ORGANIC MATTER IN SOIL COMPOSITION BASED ON A MWELO SPECIFIED SOIL ANALYSIS RESULTS FOR THE SITE SOIL. REFER TO PLANTING SPECIFICATIONS TO BE LOCATED IN THE LANDSCAPE CONSTRUCTION DRAWINGS.

FOR LANDSCAPE INSTALLATIONS, COMPOST AT A RATE OF A MINIMUM OF FOUR CUBIC YARDS PER ONE THOUSAND SQUARE FEET OF PERMEABLE AREA SHALL BE INCORPORATED TO A DEPTH OF SIX INCHES INTO THE SOIL. SOILS WITH GREATER THAN SIX PERCENT ORGANIC MATTER IN THE TOP SIX INCHES OF SOIL ARE EXEMPT FROM ADDING COMPOST AND TILLING.

PLANT SCHEDULE

РНОТО	SYMBOL	CODE	BOTANICAL / COMMON NAME	SIZE	WUCOLS	CAL	HEIGHT	MATURE SIZE (W'XH')		QTY
TREES	+	QM	QUERCUS AGRIFOLIA COAST LIVE OAK SELECTED FROM THE CITY OF MARINA LIST OF PREFERRED TREES	24" BOX	VL	1.5" CAL.	6'-8'	40° X 40°		1
РНОТО	SYMBOL	CODE	BOTANICAL / COMMON NAME	SIZE	WUCOLS	MATURE SIZE (W'XH')	ADDITIONAL		SPACING	QTY
SHRUBS		СТ	CEANOTHUS THYRSIFLORUS 'SKYLARK' SKYLARK BLUEBLOSSOM	5 GAL	L	5X5			60" o.c.	10
	•	HD	HETEROMELES ARBUTIFOLIA 'DAVIS GOLD' DAVIS GOLD TOYON	5 GAL	L	8X8			72" o.c.	2
	\odot	MD	MUHLENBERGIA DUBIA PINE MUHLY	1 GAL	L	3X3			42" o.c.	16
		MR	MUHLENBERGIA RIGENS DEER GRASS	5 GAL	Ĺ	5X5			60" o.c.	1
	•	RA	RHAMNUS ALATERNUS ITALIAN BUCKTHORN	5 GAL	i.	6'X12'			72" o.c.	10
GROUND COVERS		AR	ARCTOSTAPHYLOS UVA-URSI 'POINT REYES' POINT REYES KINNIKINNICK	1 GAL	L	1°X6°			60" o.c.	17
TO AN CAROL S		JP	JUNCUS PATENS CALIFORNIA GRAY RUSH	1 GAL	L	2X2			36" o.c.	77

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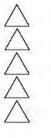
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MARINA HARBE APTS LLC

PROJECT 226 HARBEN CIRCLE MARINA CA 93933


REVISIONS



SHEET TITLE
PLANTING PLAN



SHEET NUMBER

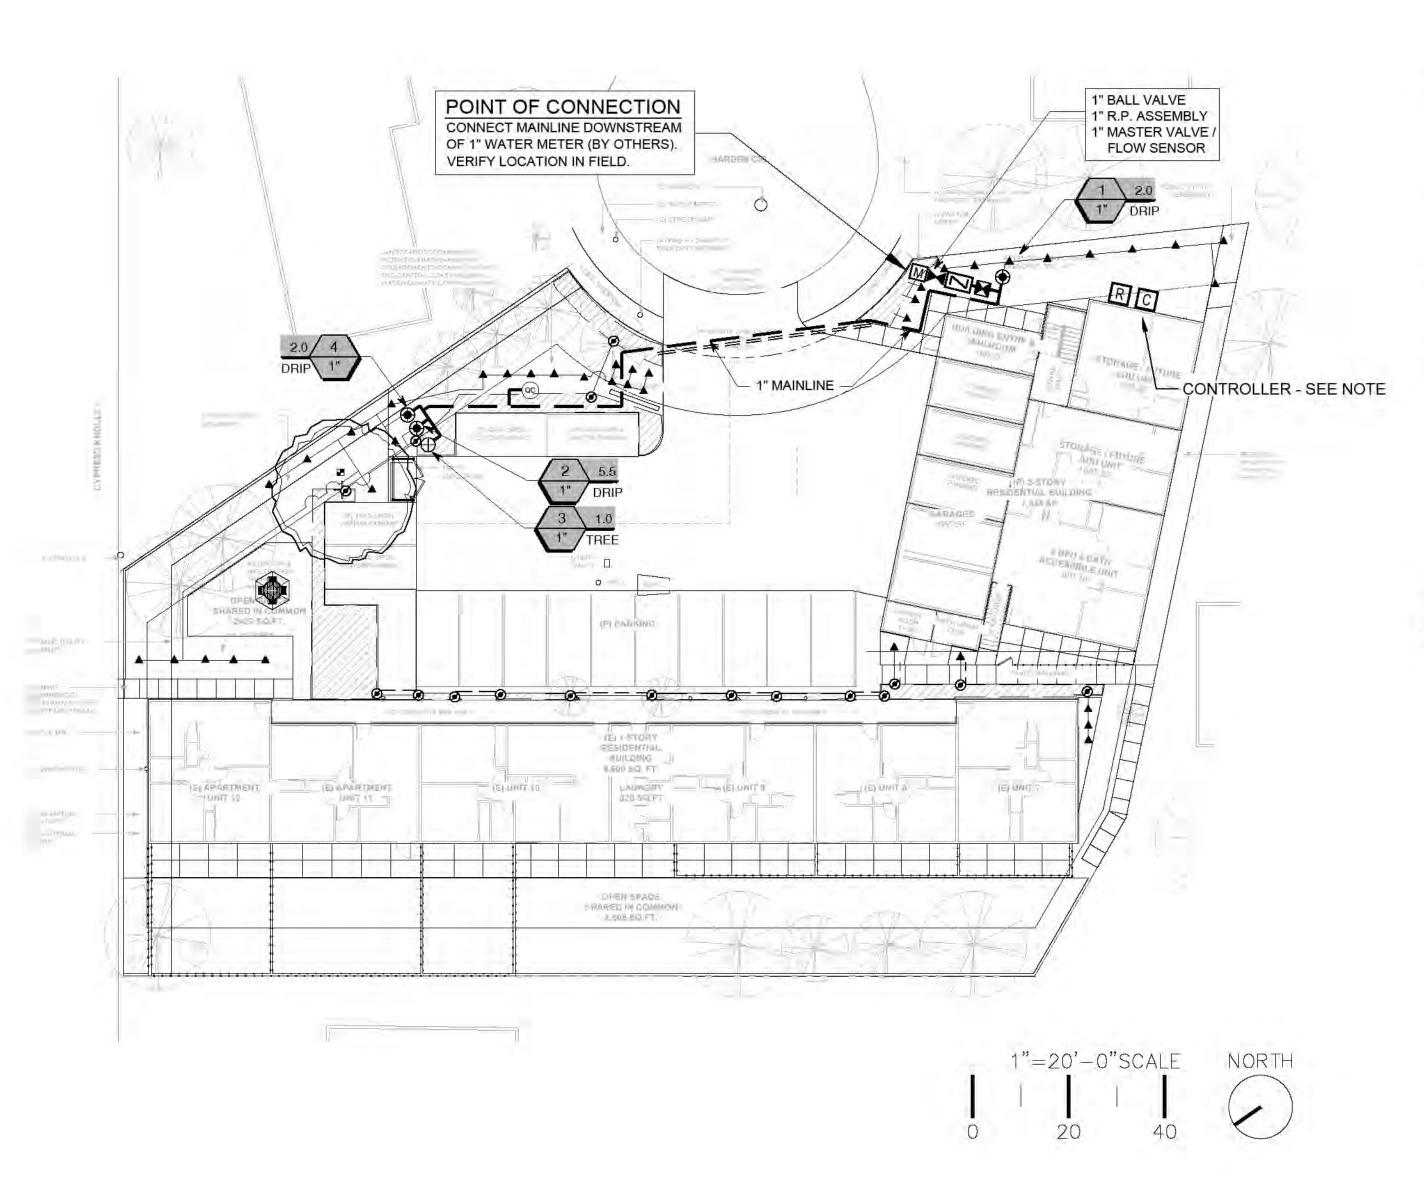

IRRIGATION DISCLAIMER

THIS DESIGN IS DIAGRAMMATIC. ALL PIPING, VALVES, AND OTHER EQUIPMENT SHOWN WITHIN PAVED AREAS OR OUT OF PROPERTY BOUNDARIES ARE FOR DESIGN CLARIFICATION ONLY, AND SHALL BE INSTALLED IN PLANTING AREAS WITHIN THE PROPERTY LINES OR LIMITS INDICATED ON PLAN. THE IRRIGATION CONTRACTOR SHALL VERIFY THE LOCATIONS OF ALL ABOVE-GRADE IRRIGATION EQUIPMENT WITH THE OWNER'S AUTHORIZED REPRESENTATIVE PRIOR TO INSTALLATION, OR IRRIGATION CONTRACTOR MAY BE REQURED TO MOVE SUCH ITEMS AT HIS OWN COST.

IRRIGATION CONTRACTOR IS RESPONSIBLE FOR VERIFYING ALL FINAL QUANTITIES PER DRAWINGS AND SPECIFICATIONS. ANY QUANTITIES PROVIDED ARE PROVIDED AS A CONVENIENCE TO THE CONTRACTOR ONLY AND SHALL NOT BE CONSIDERED ABSOLUTE.

AUTOMATIC DRAIN VALVES AND AIR RELIEF VALVES

INSTALL AUTOMATIC DRAIN VALVES AT THE LOW POINTS OF EACH LATERAL LINE (MIN. 2 PER VALVE) AS PER DETAIL ON SHEET LI-2.10 INSTALL AIR RELIEF VALVES ON DRIP SYSTEMS AT THE LCOATIONS SHOWN ON THE PLANS, AS PER DETAILS.

SLEEVING / WIRING NOTES:

IN ADDITION TO PROVIDING SLEEVES FOR ALL PIPING UNDER ROADWAYS AND WALKWAYS, THE IRRIGATION CONTRACTOR SHALL PROVIDE AND INSTALL SCH. 40 PVC SLEEVES FOR ALL CONTROLLER WIRES OCCURRING UNDER ALL ROADWAYS AND WALKWAYS. SLEEVES FOR CONTROLLER WIRES SHALL BE 2" DIA. AND CONTAIN NO MORE THAN 25 WIRES. FOR PLAN CLARITY, ONLY SOME REPRESENTATIVE SLEEVES ARE SHOWN; SOME SLEEVES MAY NOT BE SHOWN.

COORDINATION WITH EXISTING TREES

NO MACHINE TRENCHING SHALL BE PERMITTED WITHIN THE ROOT ZONE OF EXISTING TREES. HAND-DIG ONLY, WITHIN THE ROOT ZONES OF EXISTING TREES. NO ROOTS OVER 1" DIAMETER SHALL BE CUT. STAKE ALL PROPOSED TRENCH ROUTES NEAR EXISTING TREES FOR APPROVAL BY THE LANDSCAPE ARCHITECT BEFORE DIGGING BEGINS.

CONTROLLER NOTE

LOCATE CONTROLLERS AT LOCATION SHOWN ON PLAN. VERIFY LOCATION IN FIELD WITH OWNER'S REPRESENTATIVE.

120 VAC POWER TO CONTROLLER LOCATION IS NOT WITHIN THE IRRIGATION CONTRACTOR'S SCOPE OF WORK, AND SHALL BE PROVIDED BY OTHERS. HOOK-UP OF CONTROLLER TO 120 VAC SHALL BE PERFORMED BY THE IRRIGATION CONTRACTOR. IRRIGATION CONTRACTOR SHALL COORDINATE LOCATION OF WIRE SLEEVE PENETRATIONS THROUGH BUILDING WITH OWNER AND GENERAL CONTRACTOR. STATION RUN ORDER SHALL MATCH PLANS.

I HAVE COMPLIED WITH THE CRITERIA OF THE WATER EFFICIENT LANDSCAPE ORDINANCE AND APPLIED SUCH CRITERIA FOR THE EFFICIENT USE OF WATER IN THE LANDSCAPE DESIGN PLAN.

BLOCS DESIGN GROUP 3800 MAYBELLE AVE. UNIT 6 OAKLAND, CA 94619

MWELO STATEMENT

DRIPLINE SUPPLY/EXHAUST HEADER SIZING ZONE FLOW (GPM) HEADER SIZE

362	10.7.2024
BLAKE TOMILLOSO-RHINEHART, LANDSCAPE ARCHITECT	DATE
CA LICENSE #6255	08.31.24
REGISTRATION	EXP. DATE

EXP. DATE

VAL'	VE S	CHED	ULE		3-44						
Zone #	Zone GPM	Zone Type	PSI Loss at Water Meter	PSI Loss at Backflow	PSI Loss at Master Valve	PSI Loss at Mainline	PSI Loss at Zone Valve	PSI Loss at Lateral Pipe	PSI Loss at Head / Nozzle	Total PSI Required	Residual PSI
1	2	DRIP	0.1	11	0.7	0.13	2	3	30	46.93	18.07
2	5.5	DRIP	0.3	11	0.7	1.02	2	3	30	48.02	16.98
3	1	BUBBLER	0.1	11	0.7	0.04	1.8	2	25	40.64	24.36
4	2	DRIP	0.2	11	0.7	0.13	3	3	30	48.03	16.97

IRRIGATION LEGEND

GENERAL IRRIGATION NOTES

VALVE PER VALVE MANIFOLD.

PRESSURE AND FLOW NOTE

LANDSCAPE ARCHITECT FOR DIRECTION.

IRRIGATION PIPE SIZING CHART

55

80

1-1/4"

2-1/2"

0 - 5.0

5.1 - 8.0

8.1-13.0 13.1 - 22.0

22.1 - 30.0

3/4" 2"

1-1/2" 3"

2-1/2" 6"

1-1/4" 2-1/2"

INSTALLED IN SHRUB AREAS WHEREVER POSSIBLE.

SYMBOL	MANUFACTURER/MODEL
A	RAINBIRD XERI-BUG SINGLE / MULTI OUTLET (XB-T-10-PC / XBT-10-6) POINT SOURCE DRIP EMITTERS. SEE INSTALLATION DRIP NOTE # N REGARDING EMITTER LAYOUT AND CONNECTION TO DRIP VALVE ASSEMBLY
	RAINBIRD RWS ROOT WATERING SYSTEM MODEL RWS-M-B-C-1402 WITH RWS-SOCK. (TWO PER TREE)
•	RAINBIRD XCZ-100-PRB-COM / 150-PRB-COM SERIES AUTOMATIC DRIP VALVE ASSEMBLY WITH 40 PSI PRESSURE REGULATOR
	XCZ-100-PRB-COM - 1" BALL VALVE WITH 1" PESB VALVE AND 1" PRESSURE REGULATING 40PSI QUICK-CHECK BASKET FILTER. 0.3GPM TO 20GPM.
\oplus	RAINBIRD PEB SERIES ELECTRIC REMOTE CONTROL, "TREE BUBBLER ZONE" VALVE
	AREA TO RECEIVE DRIPLINE RAINBIRD XFS-CV-06-12 SERIES DRIP TUBE IN SHRUB BED INSTALLED AT 2" DEPTH
<i>⊕</i>	PIPE TRANSITION POINT ABOVE GRADE PIPE TRANSITION POINT FROM PVC LATERAL TO DRIP TUBING WITH RISER TO ABOVE GRADE INSTALLATION.
Z	ZURN / WILKINS 375XLB SERIES <u>REDUCED PRESSURE</u> TYPE BACKFLOW PREVENTOR INSTALLED PER CITY CODE WITH SAME SIZE BRONZE BALL VALVE INSTALLED ON THE UP-STREAM SIDE.MOUNTED IN STRONGBOX SMOOTH TOUCH ENCLOSURE
H	LASCO "V" SERIES SCH. 80 PVC TRUE UNION BALL VALVE, MAINLINE SIZE
M	IRRIGATION WATER METER AND TAP (BY OTHERS) SIZE AS NOTED ON THE PLAN
(ac)	RAINBIRD 33DLRC QUICK COUPLER, 3/4"
С	RAINBIRD ESP12LXMEF2P SERIES AUTOMATIC WALL MOUNT CONTROLLER
R	RAINBIRD WR2-RFC RAIN / FREEZE SENSOR - CONFIRM SENSOR LOCATION WITH OWNERS REPRESENTATIVE
	1" MASTER VALVE MODEL # 100-EFB-CP WITH RAINBIRD FLOW SENSOR MODEL #FS100B SERIES

IRRIGATION LATERAL LINE: SCHEDULE 40 PVC

IRRIGATION MAINLINE: SCHEDULE 40 PVC = = = = = = IRRIGATION SLEEVES, SCH. 40 PVC, MIN. TWICE SIZE OF PIPE TO BE INSERTED

A. ALL IMPROVEMENTS SHALL COMPLY WITH THE STANDARD UNIFORM BUILDING CODE. B. THIS IRRIGATION DESIGN IS DIAGRAMMATIC. ALL IRRIGATION EQUIPMENT SHOWN WITHIN PAVED OR BUILDING AREAS ARE FOR DESIGN CLARIFICATION ONLY AND SHALL BE

C. MATERIAL COUNTS ARE APPROXIMATIONS AND SHOULD NOT BE TAKEN TO BE AN EXACT AMOUNTS. CONTRACTOR IS RESPONSIBLE FOR THEIR OWN MATERIAL

D. IRRIGATION CONTROL VALVES SHALL BE INSTALLED TOGETHER IN VALVE MANIFOLDS

AS MUCH AS POSSIBLE. CONTRACTOR SHALL INSTALL ONE (1) SHUT-OFF BALL

G. IT IS CONTRACTOR'S RESPONSIBILITY TO KEEP THE EXISTING IRRIGATION SYSTEM IN OPERABLE CONDITION THROUGHOUT THE CONSTRUCTION PERIOD. THE SCOPE OF RESTORING AND REPAIRING OF EXISTING SYSTEM SHALL INCLUDE, BUT NOT LIMITED TO CAPPING-OFF LATERAL END LINES AND MAINLINES, REROUTING MAINLINE AND CONTROL WIRES, AND RELOCATING VALVES OR REPLACING PER EXISTING STANDARDS

ASSUME WATER PRESSURE TO BE 65 PSI AND FLOW TO BE 14 GPM. CONTRACTOR SHALL VERIFY BEFORE ANY INSTALLATION. IF LESS THAN DESIGN INTENT, CALL

(GPM AT 5 FEET PER SECOND)

50

70

110

CONTRACTOR SHALL SIZE ALL LATERAL PIPE ACCORDING TO THIS SIZING LEGEND. 3/4"

3/4" PVC PIPE OR RAIN BIRD QF-HEADER

1" PVC PIPE OR RAIN BIRD QF-HEADER

19 - 24

25 - 36

37-48

49-72

73-90

91-110

45

70

100

2-1/2"

4"

CONTROLLER WIRES SCH.

PIPE SIZE PVC CL 200 PVC CL 315 PVC SCH 40 COPPER TYPE 'K'

PIPE SHALL BE SMALLEST ALLOWABLE SIZE, NO 1/2" PIPE SHALL BE USED.

3/4" PVC PIPE OR DRIPLINE TUBING

50

70

100

1-1/4" PVC PIPE

1-1/2" PVC PIPE

SLEEVE CHART FOR IRRIGATION PIPE

PIPE SCH. 40/80 PVC SLEEVE SIZE

40/80 PVC SLEEVE SIZE

E. ONE (1) SHUT-OFF BALL VALVE SHALL BE INSTALLED PRIOR TO ANY STREET

F. CONTRACTOR SHALL INSTALL ADDITIONAL INLINE CHECK VALVES AS NEEDED.

*** CONTRACTOR TO VERIFY BORE AND SLEEVE AT EXISTING PAVEMENT LOCATIONS PRIOR TO CONSTRUCTION

VALVE KEY

	Valve Callout
/ # • \ # •	Valve Nur Valve Flo
#"•/	Valve Size

WATER CONSERVATION

IRRIGATION WATER CONSERVATION SHALL BE ACCOMPLISHED THROUGH THE FOLLOWING EFFORTS:

- SEPARATE TREE / SHRUB ZONES FOR SCHEDULING ADJUSTMENT
- 2. NO OVERSPRAY ONTO PAVEMENT PERMITTED
- 3. USE OF RAIN SENSOR SHUT OFF OVER-RIDE DEVICE

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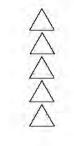
916 716 9331



HARBEN

26

REVISIONS



SHEET TITLE IRRIGATION PLAN



SHEET NUMBER

Reduced ODS SR 226 Harben Cir 11-25-2024

Final Audit Report 2024-11-26

Created: 2024-11-26

By: Nick McIlroy (nmcilroy@cityofmarina.org)

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